

## The current proposal is:

Preservation Department – Item 3, LPC-24-08616

# 891 St Mark's Avenue – Crown Heights North Historic District Borough of Brooklyn

To testify virtually, please join Zoom

Webinar ID: 820 4014 2259

Passcode: 476351

By Phone: 646-558-8656 (NY)

877-853-5257 (Toll free) US

888-475-4499 (Toll free)

**Note**: If you want to testify virtually on an item, join the Zoom webinar at the agenda's "Be Here by" time (about an hour in advance). When the Chair indicates it's time to testify, "raise your hand" via the Zoom app if you want to speak (\*9 on the phone). Those who signed up in advance will be called first.



1940 HISTORIC PHOTO SCALE: NTS



CURRENT CONDITION @ FRONT FACADE



CONSULTANT

#T No. of Treads #R No. of Risers AD Area Drain AFF Above Fin Floor BO Bottom of CL Center Line

IGU Insulated Glass Unit PSF Pounds per Sq Foot

TEMP Temporary
TYP Typical
T/ Top of
TO Top of
VIF Verify in Field Combo SD/CO

OWNER'S SIGNATURE

HILLBERTZ/MOZO STOOP REPLACEMENT

891 ST. MARK'S AVE BROOKLYN, NY 11213


SCALE DRAWN
AS NOTED MPH

DRAWING SERIES

HISTORIC PHOTO & EXISTING CONDITIONS

LPC-001.00 SHEET 01 OF 12

Copyright © 2020 by nC2 architecture llc. All rights reserved.

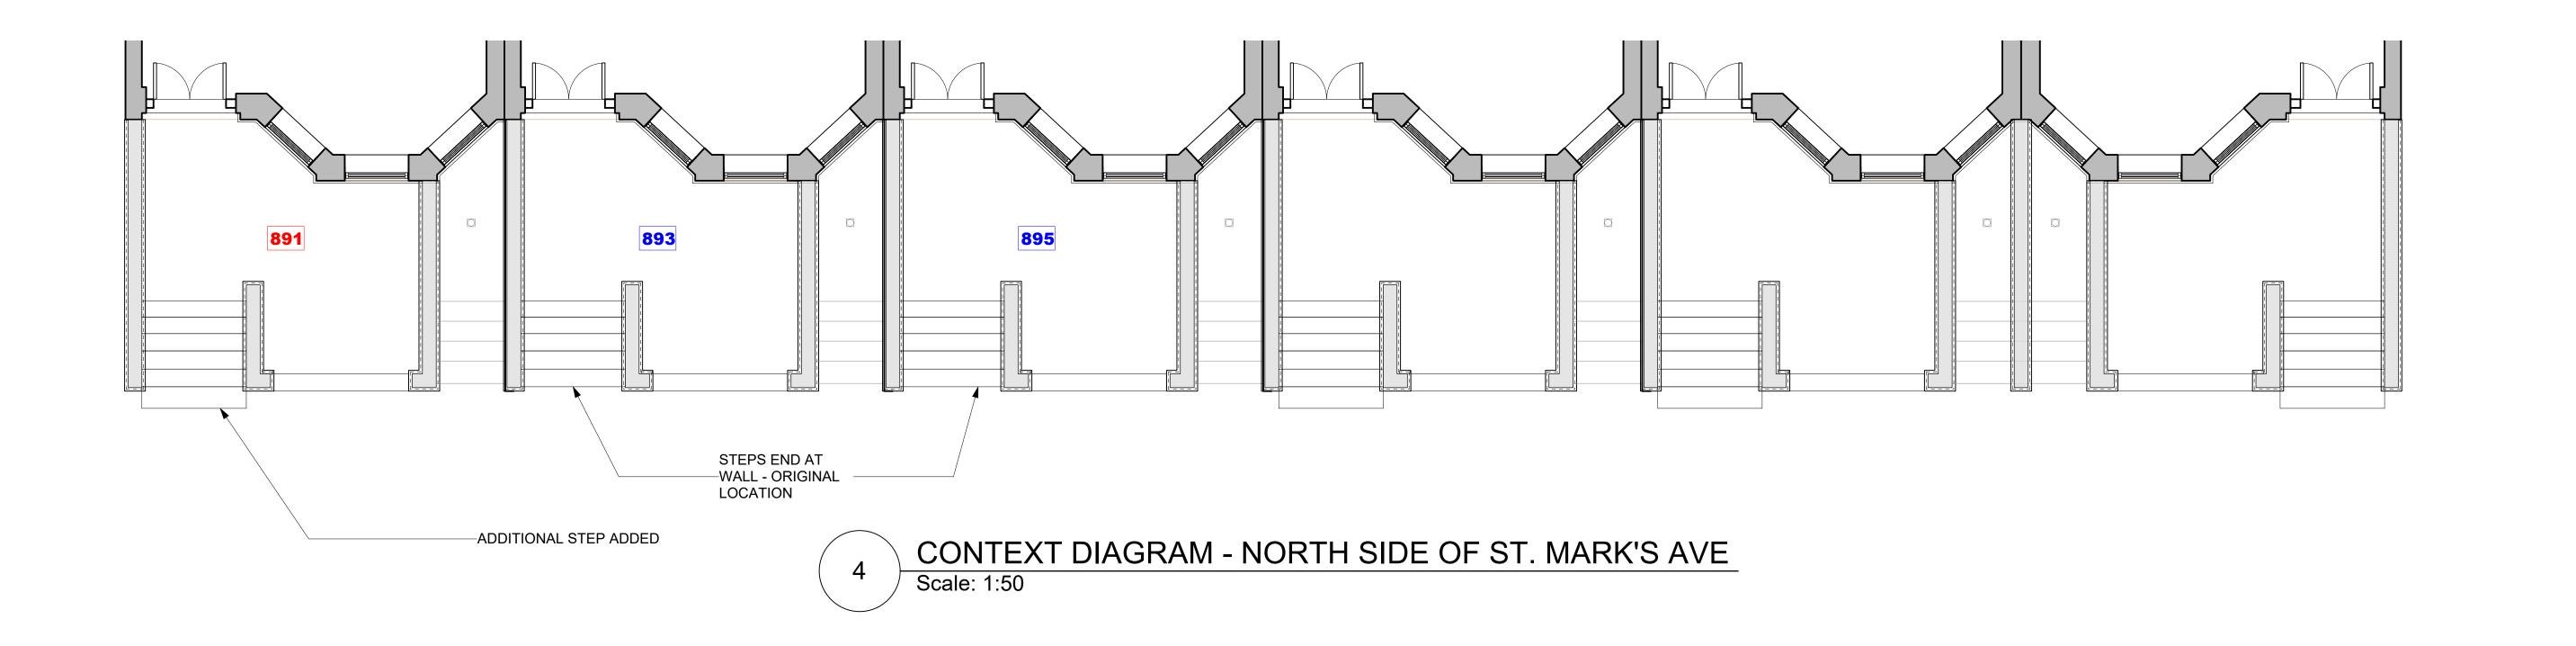



CONSULTAN

CONSU

Existing Wall

Mew Wall

Demolition

Line Above
Line Below

Line Above
Line Below
Property Line
Fire Separation
1-Hour (1-HR)
2-Hour (2-HR)
3-Hour (3-HR)

- Property Line
Fire Separation
1-Hour (1-HR)
2-Hour (2-HR)
3-Hour (3-HR)
FO
Fo
Fo
Finished Floor
FI
F

#T No. of Treads
#R No. of Risers
AD Area Drain
AFF Above Fin Floor

BO Bottom of

Drain

GWB
Gypsulfi Walloodd
IGU
Insulated Glass Unit
Minimum
MAX
Exhaust Register
Exhaust Fan
Recessed Dnlight
Smoke Detector
CO Detector
CO Detector
CO Detector
Detector
Detector
Fig. 1

GWB
Gypsulfi Walloodd
Insulated Glass Unit
Minimum
Maximum
PSI
Pounds per Sq Inch
RO
Rough Opening
SF
Square Foot
SI
Square Inch
SG
Safety Glass
Temporary
Typical
T/
Top of
TO
Top of
VIF
Verify in Field

SEAL

OWNER'S SIGNATUR

HILLBERTZ/MOZO STOOP REPLACEMENT

891 ST. MARK'S AVE BROOKLYN, NY 11213

REVISION NO DATE DESCR

ATE SCALE DRAWN
9/28/2024 AS NOTED MPH

09/28/2024 AS NOTED

DRAWING SERIES

LPC


DWG NAME

NEIGHBORHOOD CONTEXT

LPC-002.00

SHEET 02 OF 12

Copyright © 2020 by nC2 architecture Ilc. All rights reserved.

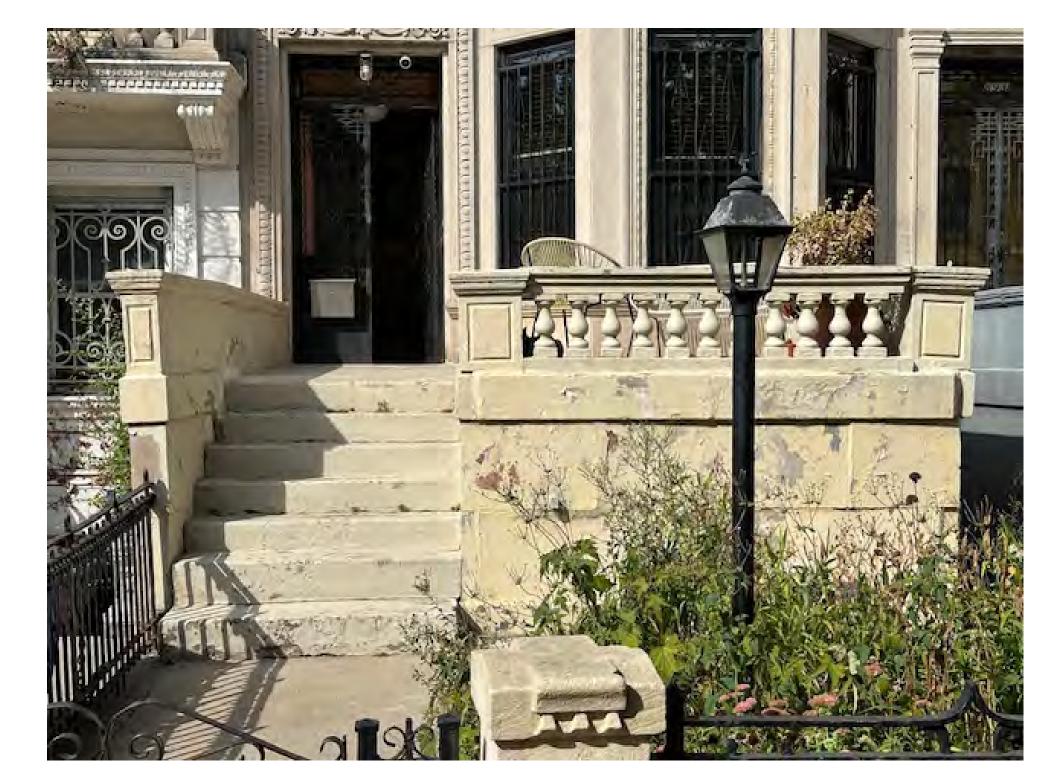







CONTEXT - 891 ST. MARK'S

SCALE: NTS

2 CONTEXT - 893 ST. MARK'S

3 CONTEXT - 895 ST. MARK'S

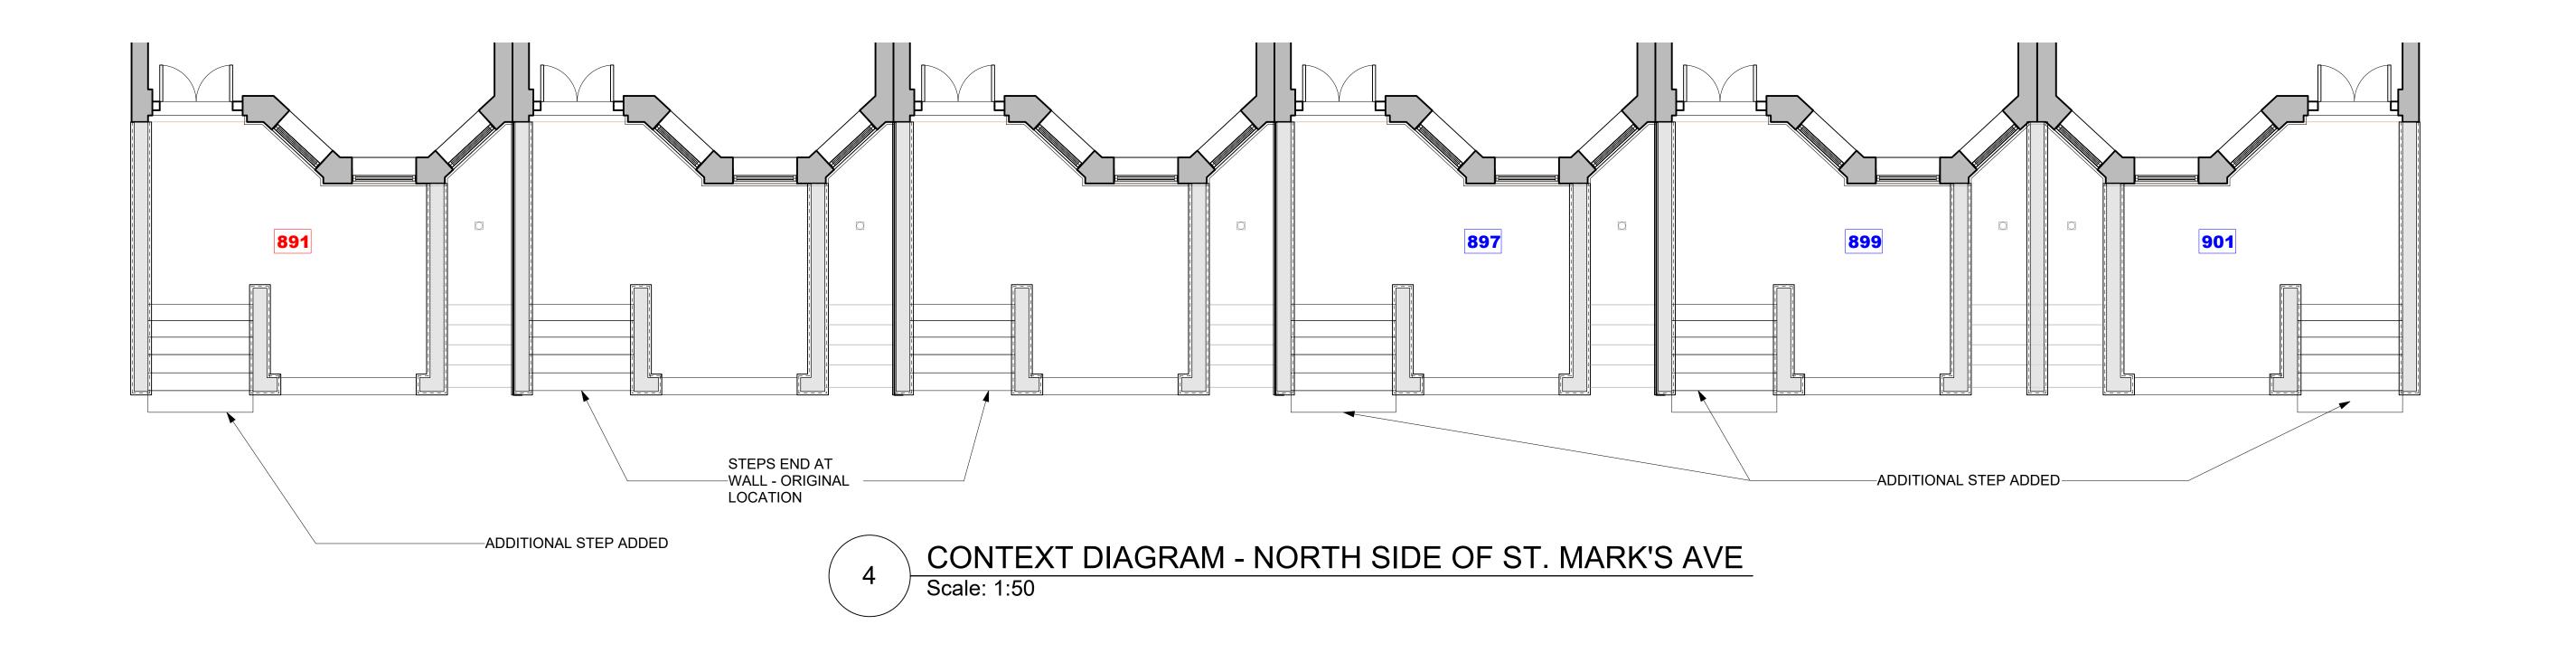

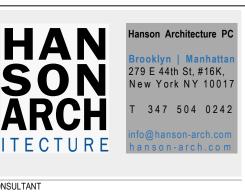


#T No. of Treads #R No. of Risers AD Area Drain AFF Above Fin Floor ---- Line Above BO Bottom of ----- Line Below CL Center Line EX'G Existing FD Floor Drain

1-Hour (1-HR) 2-Hour (2-HR) 3-Hour (3-HR)

IGU Insulated Glass Unit PSF Pounds per Sq Foot TEMP Temporary
TYP Typical
T/ Top of
TO Top of
VIF Verify in Field Combo SD/CO Detector





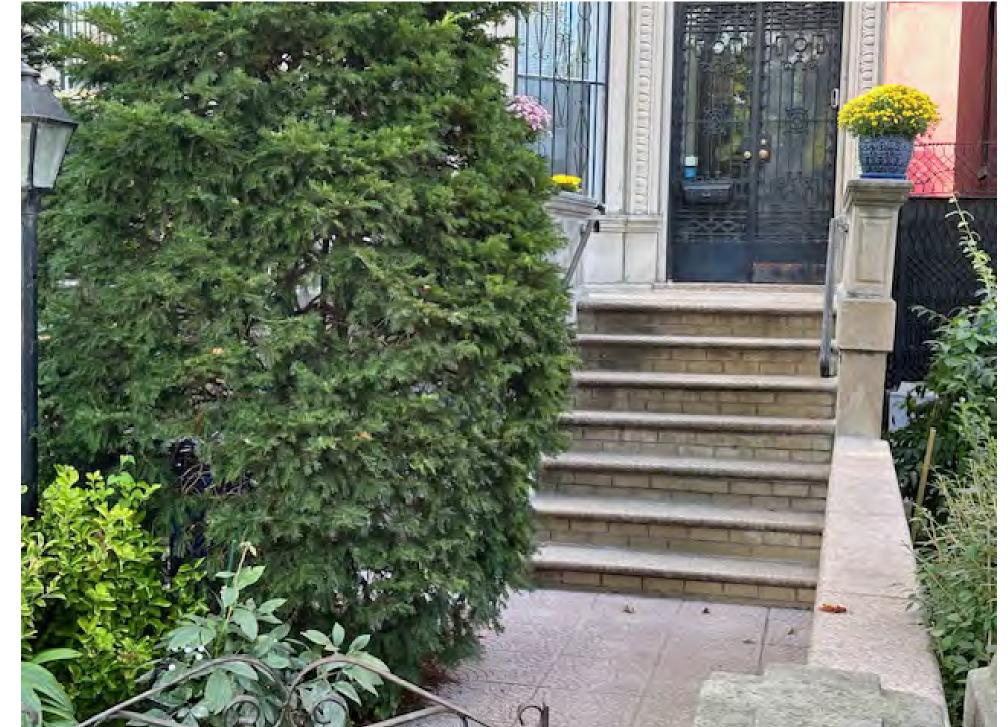

OWNER'S SIGNATURE

HILLBERTZ/MOZO STOOP REPLACEMENT

891 ST. MARK'S AVE BROOKLYN, NY 11213

REVISION NO DATE DESCR

SCALE DRAWN
AS NOTED MPH

NEIGHBORHOOD CONTEXT


LPC-003.00 SHEET 03 OF 12

Copyright © 2020 by nC2 architecture llc. All rights reserved.

CONTEXT - 897 ST. MARK'S SCALE: NTS

CONTEXT - 899 ST. MARK'S

CONTEXT - 901 ST. MARK'S

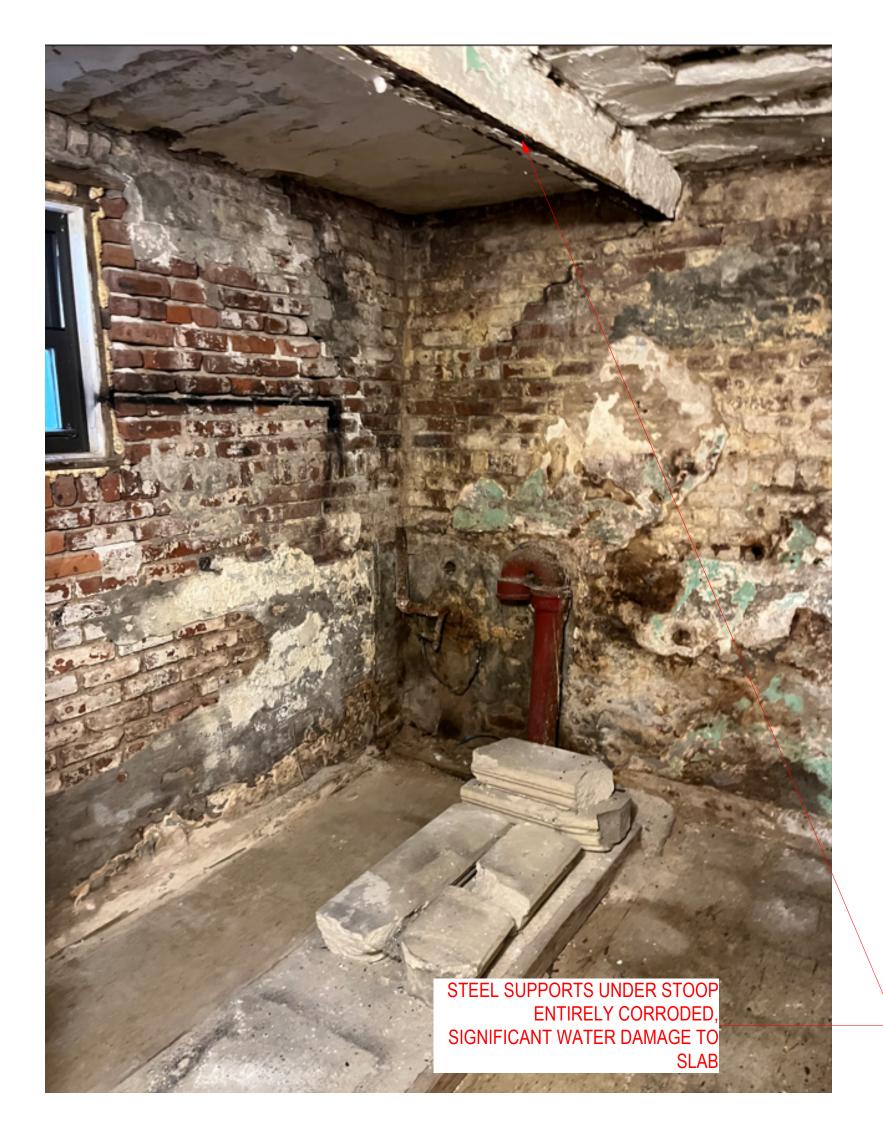





INT DTL - CORRODED SUPPORTS SCALE: NTS

INT DTL - CORRODED SUPPORTS

STOOP EXTERIOR CONDITION

Brooklyn | Manhattan 279 E 44th St, #16K, New York NY 10017

#T No. of Treads #R No. of Risers AD Area Drain AFF Above Fin Floor

BO Bottom of CL Center Line FD Floor Drain

IGU Insulated Glass Unit

PSF Pounds per Sq Foot TEMP Temporary
TYP Typical
T/ Top of
TO Top of
VIF Verify in Field Combo SD/CO Detector

OWNER'S SIGNATURE

HILLBERTZ/MOZO STOOP REPLACEMENT

891 ST. MARK'S AVE BROOKLYN, NY 11213

NO DATE DESCR

SCALE DRAWN
AS NOTED MPH

DRAWING SERIES


LPC

**EXISTING CONDITIONS &** PROBES

LPC-004.00 SHEET 04 OF 12

Copyright © 2020 by nC2 architecture llc. All rights reserved.



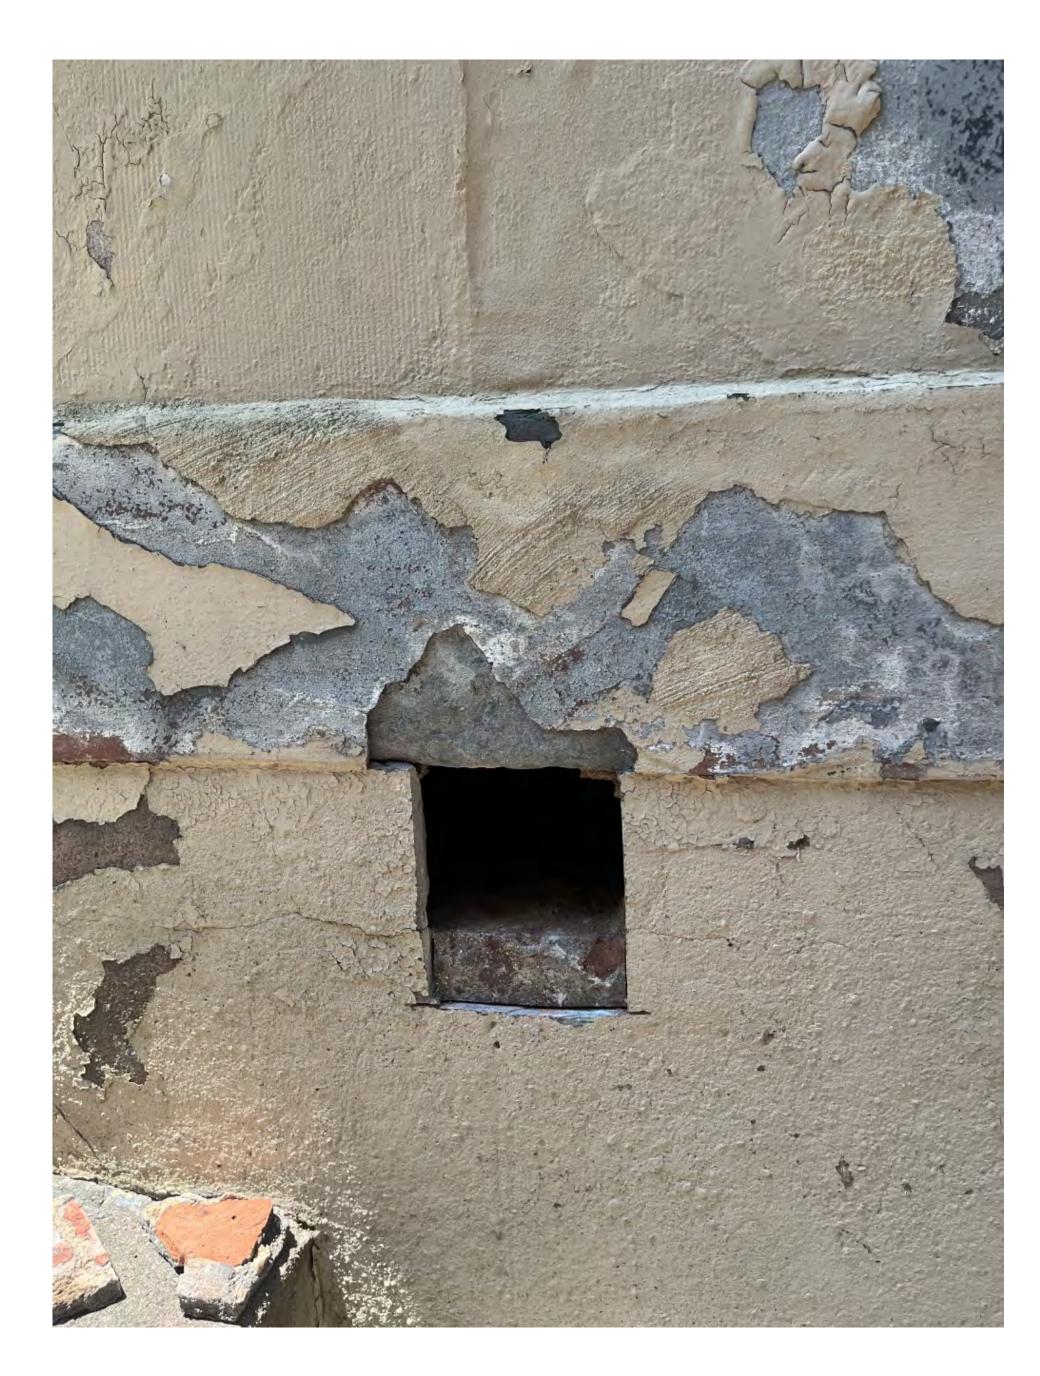





BLUESTONE SLAB

EXTERIOR PROBE

INTERIOR PROBE CONDITION SCALE: NTS

3 PROBE STUCCO DETAIL
SCALF: NITS

#T No. of Treads #R No. of Risers AD Area Drain AFF Above Fin Floor BO Bottom of ----- Line Below CL Center Line IGU Insulated Glass Unit PSF Pounds per Sq Foot TEMP Temporary
TYP Typical
T/ Top of
TO Top of
VIF Verify in Field

OWNER'S SIGNATURE

HILLBERTZ/MOZO STOOP REPLACEMENT

891 ST. MARK'S AVE BROOKLYN, NY 11213


SCALE DRAWN
AS NOTED MPH

DRAWING SERIES

EXISTING CONDITIONS & PROBES


LPC-005.00

SHEET 05 OF 12 Copyright © 2020 by nC2 architecture llc. All rights reserved.

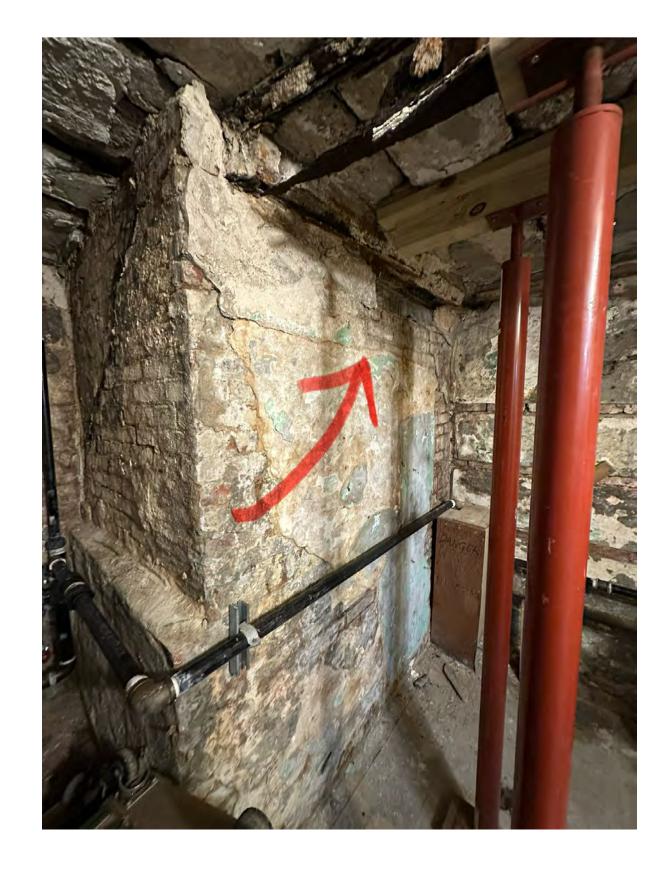





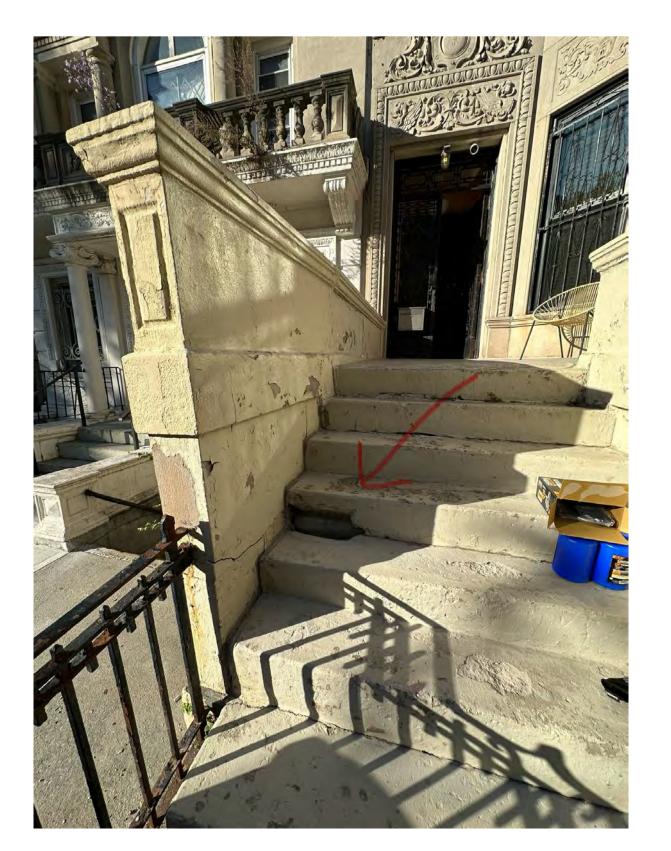



EXISTING STEP CONDITION - EXTERIOR

SCALE: NTS

HAN	Hanson Architecture PC
SON	Brooklyn   Manhattan 279 E 44th St, #16K, New York NY 10017
ARCH	T 347 504 0242
TECTURE	info@hanson-arch.com hanson-arch.com

CONSULTANT

CONSULTANT

Existing Wall #T No. of Treads
#R No. of Risers
AD Area Drain
AFF Above Fin Floor
----- Line Above B/ Bottom of
----- Property Line
EX'G Existing

Line Below
Property Line

Fire Separation
1-Hour (1-HR)
2-Hour (2-HR)
3-Hour (3-HR)
4-21'-8"

Line Below
BO
Bottom of
CL
Center Line
EX'G
Existing
FD
Floor Drain
FF
Finished Floor
FL
Floor
FO
Finished Opening
GA
Gauge
GWB
Gypsum Wallboar

2-Hour (2-HR)
3-Hour (3-HR)
FD
FO
Finished Opening
GA
Gauge
GWB
Gypsum Wallboard
IGU
Insulated Glass Unit
MIN
Minimum
MAX
Exhaust Register
Exhaust Fan
Exhaust Fan
Recessed Dnlight
SIM
Similar
Smoke Detector
SI
Square Foot
SI
Square Inch
Safety Glass

Smoke Detector

SI Square Inch

SG Safety Glass

Combo SD/CO

Detector

TYP Typical

T/ Top of

TO Top of

VIF Verify in Field

QEAI

HILLBERTZ/MOZO STOOP REPLACEMENT

891 ST. MARK'S AVE BROOKLYN, NY 11213

NO DATE

09/28/2024 AS NOTED

DRAWING SERIE

DWG NAME


EXISTING CONDITIONS & PROBES

DWG NO.


LPC-006.00

SHEET 06 OF 12

Copyright © 2020 by nC2 architecture llc. All rights reserved.

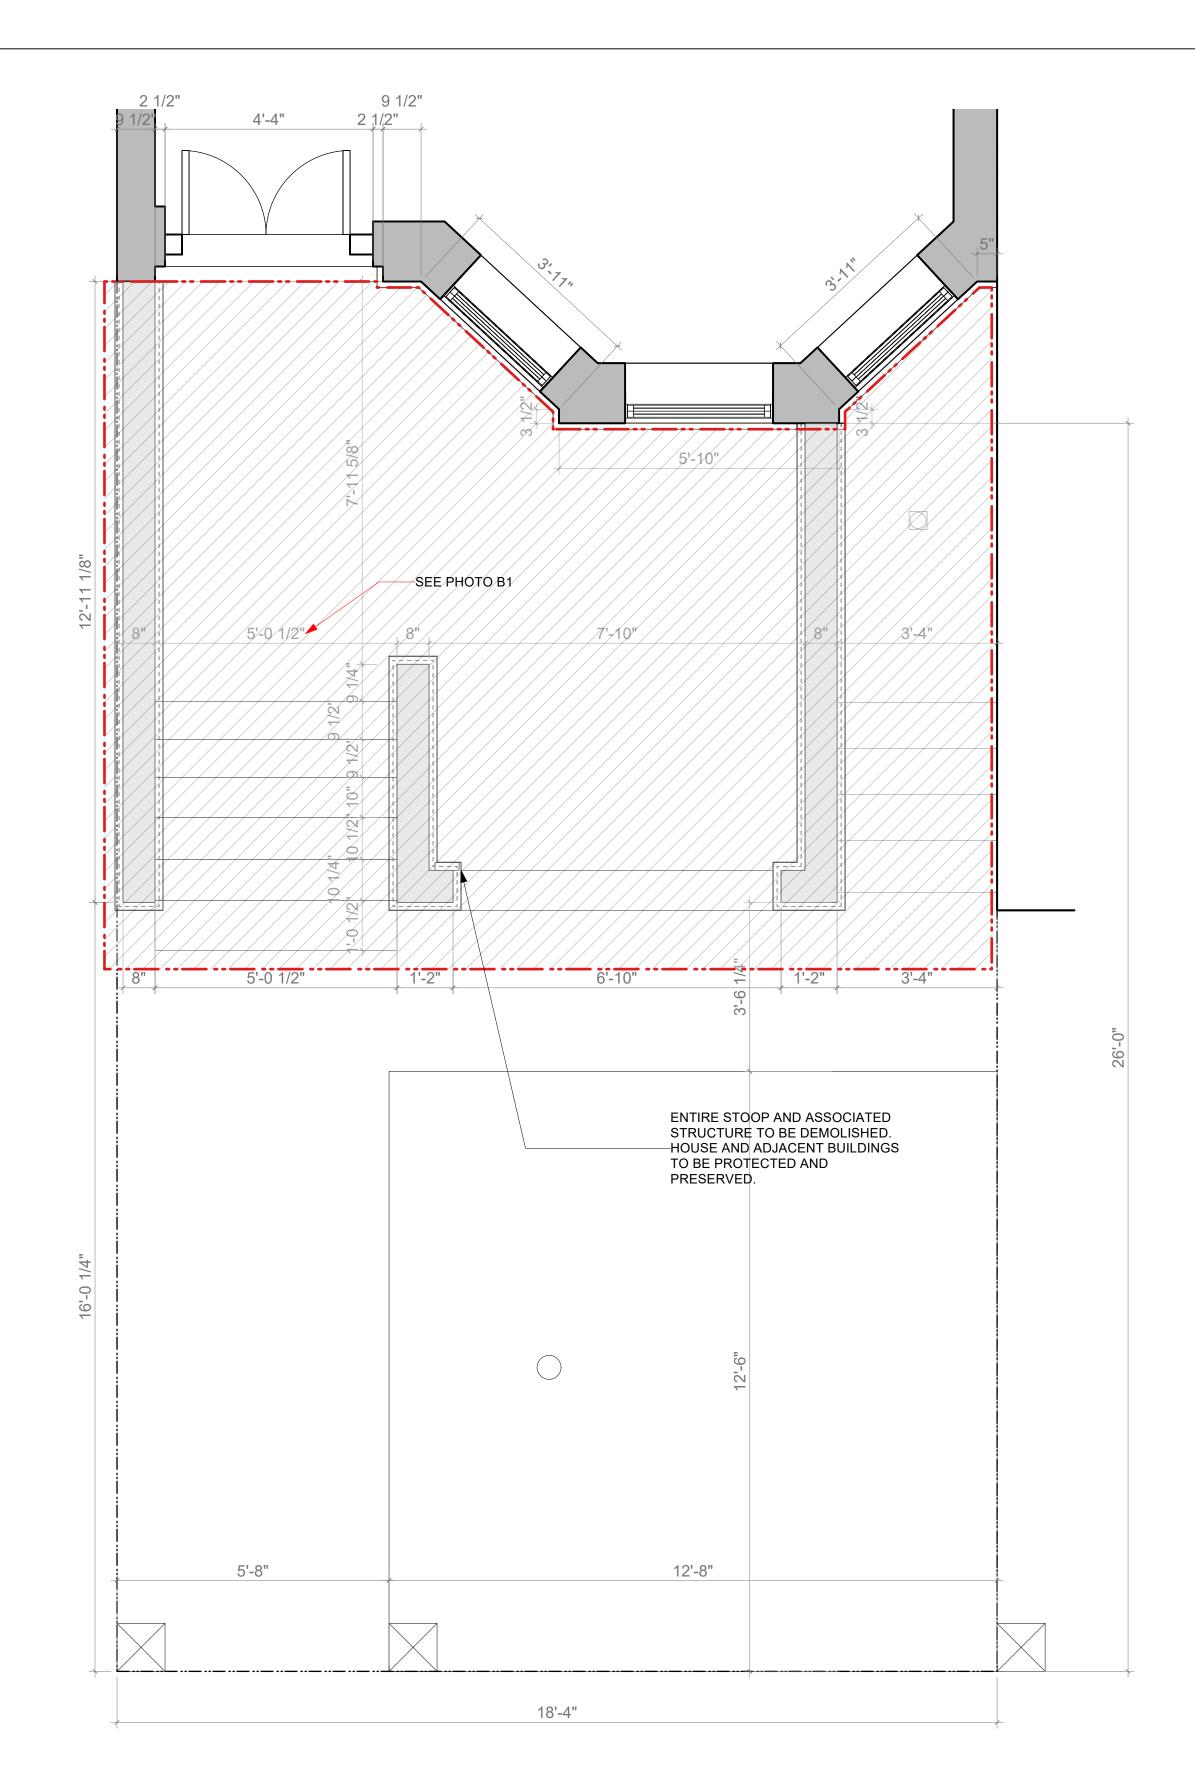

PARTIAL STOOP LEVEL EXISTING
Scale: 1/2" = 1'-0"

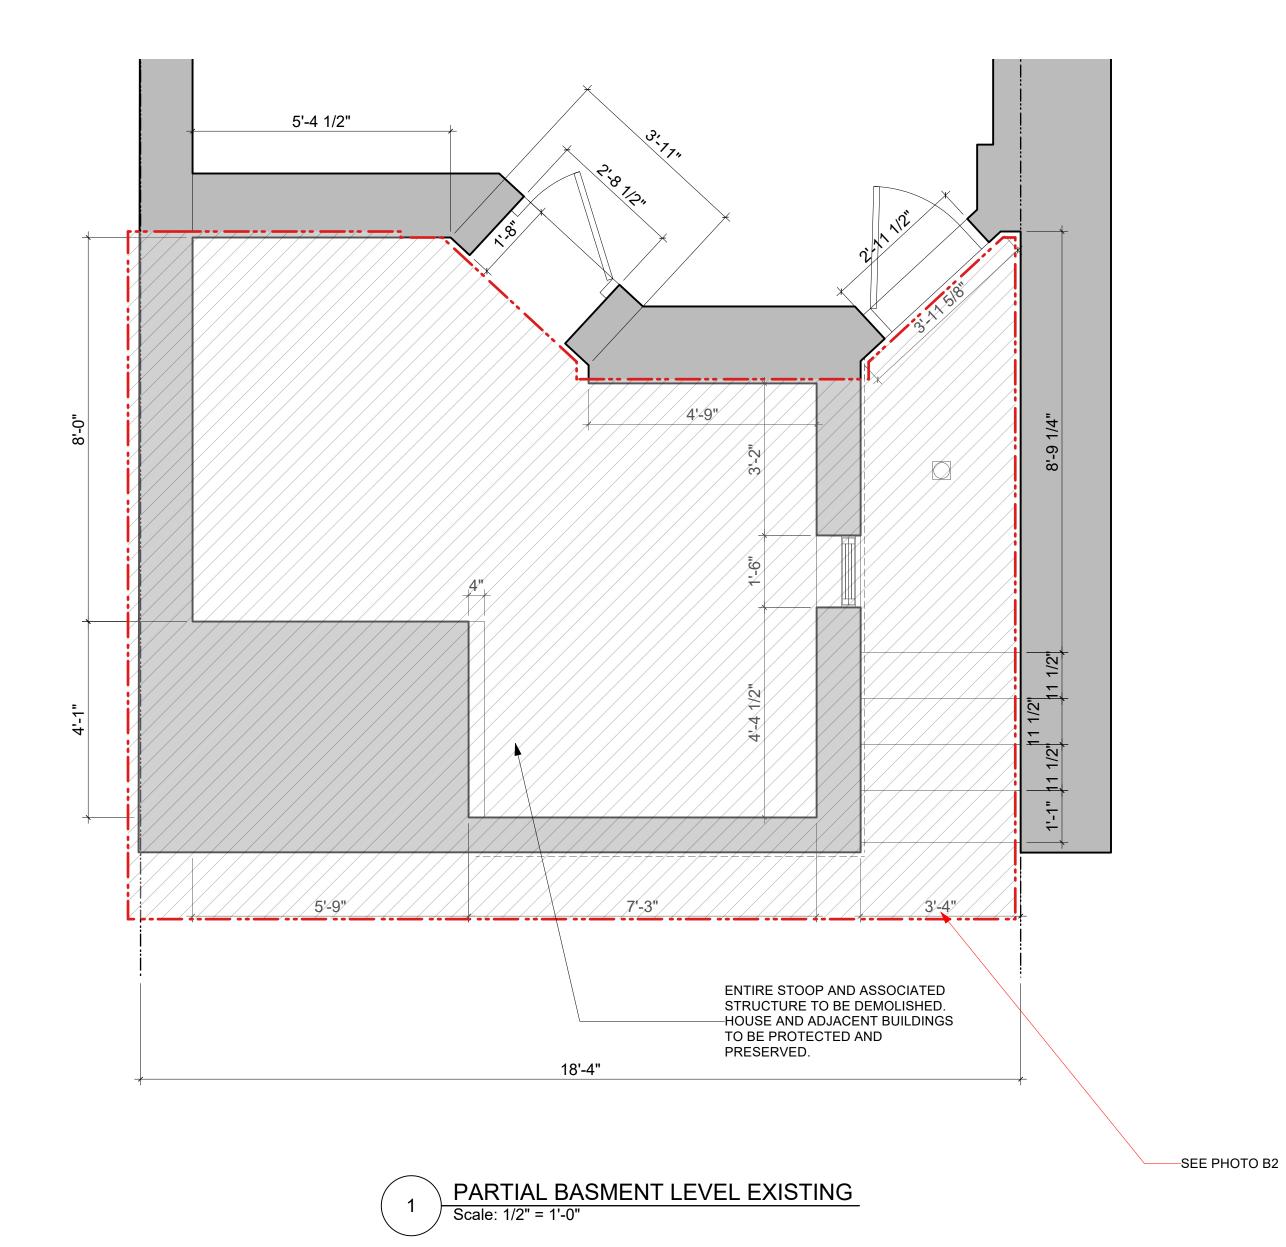





CONSULTANT

#T No. of Treads #R No. of Risers ---- Demolition

---- Line Above ----- Line Below — --- Property Line 1-Hour (1-HR)

EX'G Existing Fire Separation FD Floor Drain 2-Hour (2-HR) 3-Hour (3-HR) FO Finished Opening 3RD FL FF + 21'-8" Spot Elevation GWB Gypsum Wallboard IGU Insulated Glass Unit PSI Pounds per Sq Inch

PSF Pounds per Sq Foot RO Rough Opening SF Square Foot SI Square Inch SG Safety Glass Combo SD/CO

TEMP Temporary
TYP Typical
T/ Top of
TO Top of
VIF Verify in Field

AD Area Drain AFF Above Fin Floor

B/ Bottom of

BO Bottom of

CL Center Line

OWNER'S SIGNATURE

HILLBERTZ/MOZO STOOP REPLACEMENT

891 ST. MARK'S AVE BROOKLYN, NY 11213

NO DATE DESCR


SCALE DRAWN
AS NOTED MPH

DRAWING SERIES
PROPOSED WORK


EXISTING/DEMO PLANS

LPC-007.00 SHEET 07 OF 12


Copyright © 2020 by nC2 architecture llc. All rights reserved.

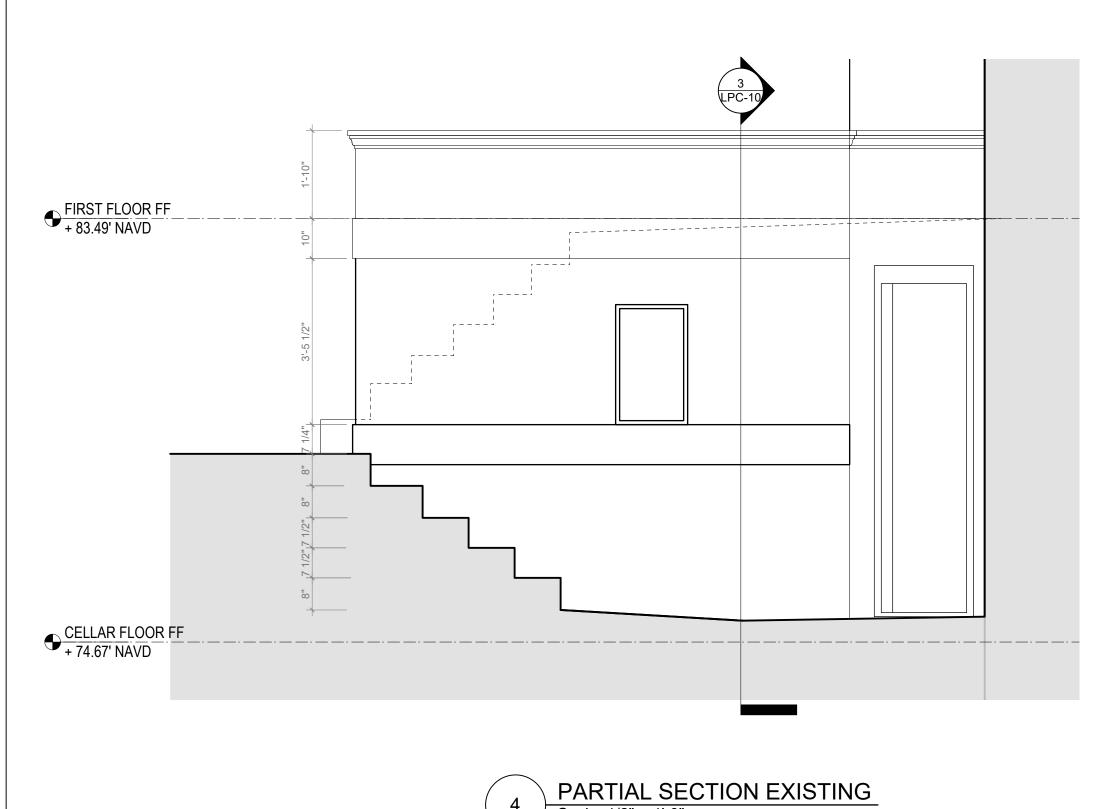




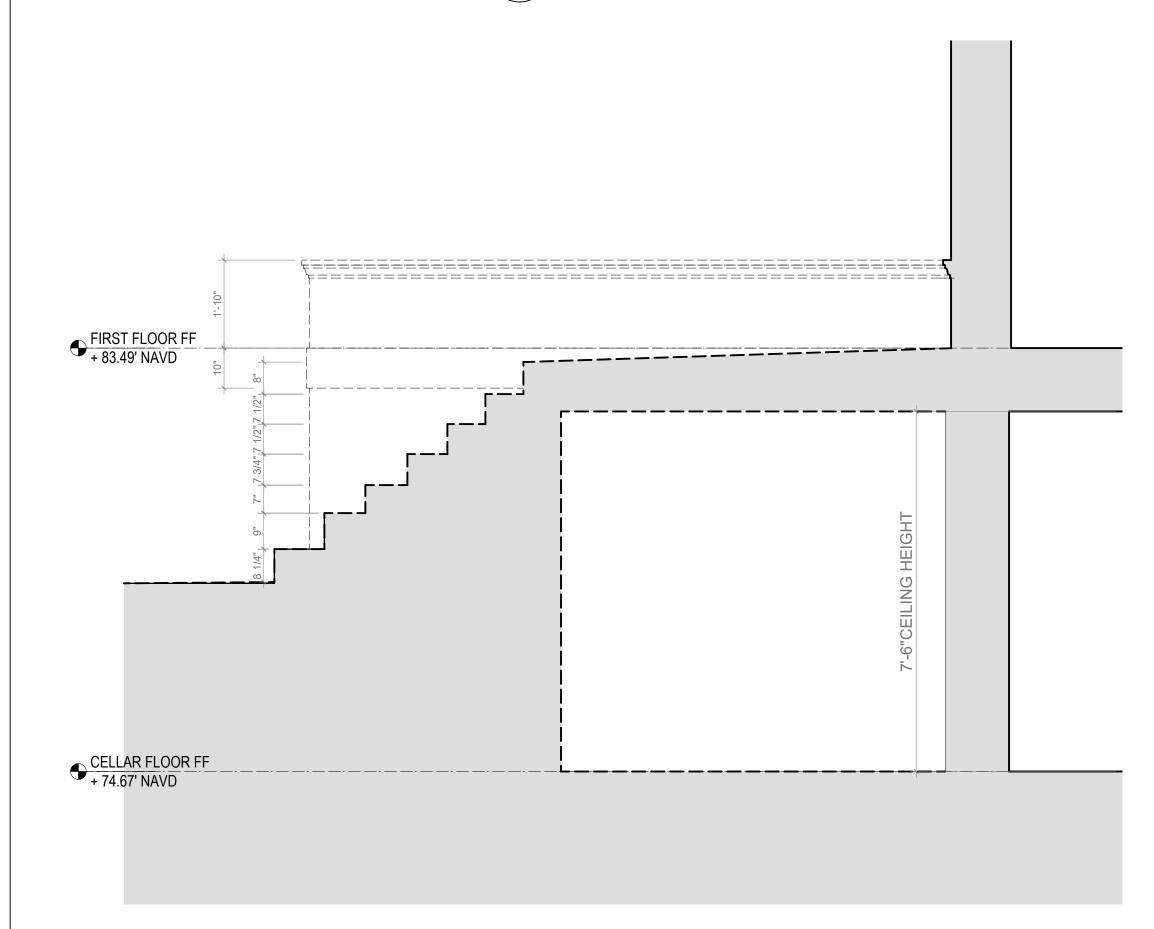

PARTIAL SECTION EXISTING
Scale: 1/2" = 1'-0"

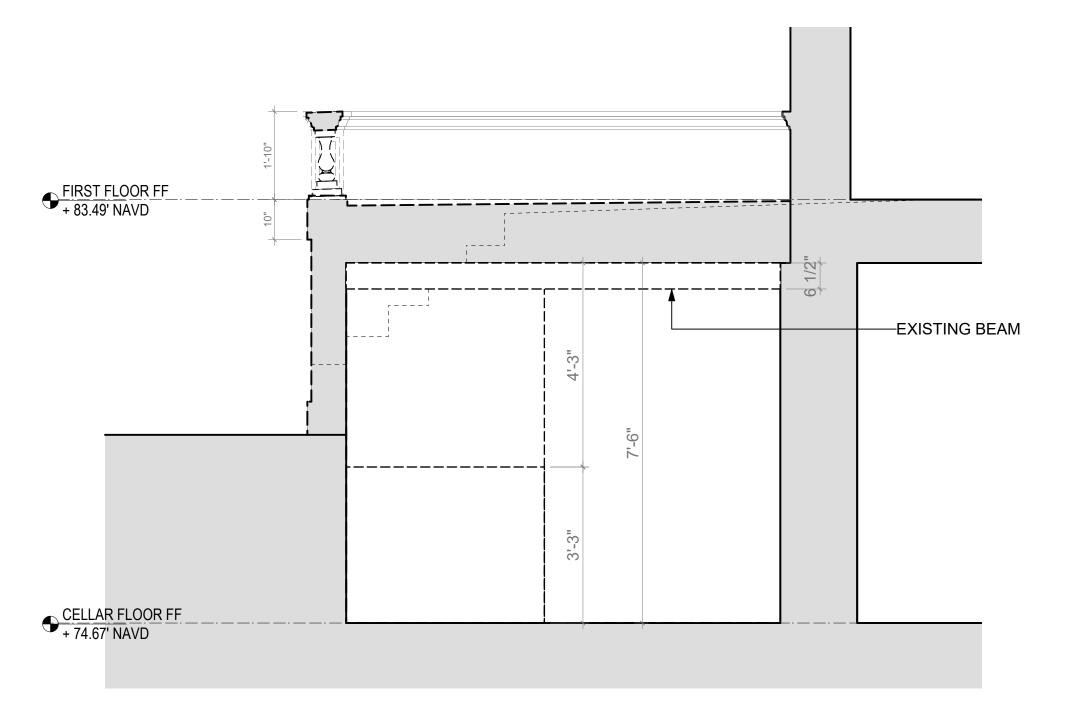

# PARTIAL SECTION EXISTING

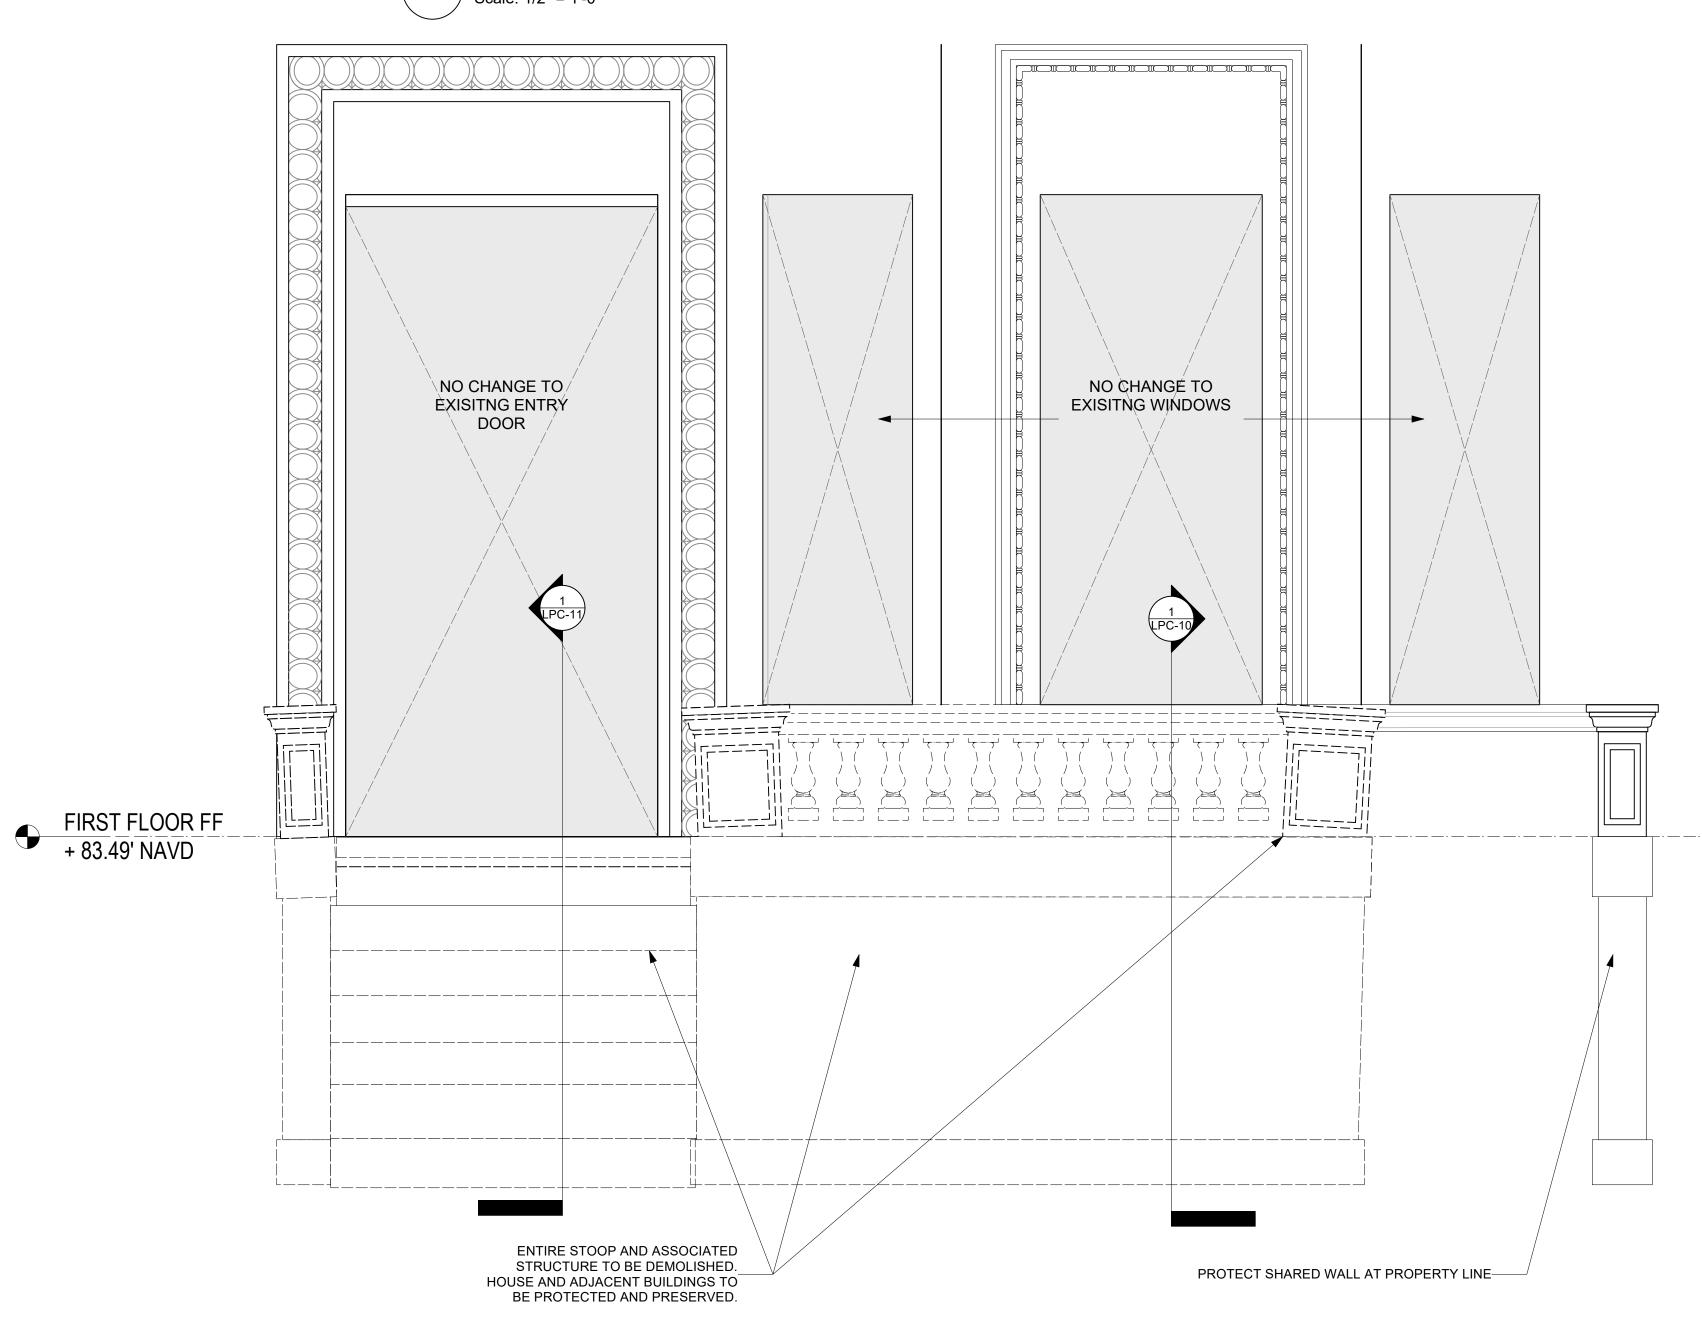

PARTIAL FRONT ELEVATION EXISTING
Scale: 3/4" = 1'-0"



CONSULTANT

LEGEND # T No. of Treads # R No. of Risers AD Area Drain AFF Above Fin Floor ---- Demolition B/ Bottom of ---- Line Above BO Bottom of ----- Line Below CL Center Line — -- Property Line EX'G Existing Fire Separation FD Floor Drain 1-Hour (1-HR) Finished Floor FO Finished Opening GA Gauge GWB Gypsum Wallboard

2-Hour (2-HR) 3-Hour (3-HR) Spot Elevation IGU Insulated Glass Unit Exhaust Register PSI Pounds per Sq Inch PSF Pounds per Sq Foot Recessed Dnlight Smoke Detector CO Detector Combo SD/CO

RO Rough Opening SF Square Foot SI Square Inch SG Safety Glass TEMP Temporary
TYP Typical
T/ Top of
TO Top of VIF Verify in Field

OWNER'S SIGNATURE

HILLBERTZ/MOZO STOOP REPLACEMENT

ADDRESS 891 ST. MARK'S AVE BROOKLYN, NY 11213

REVISION NO DATE DESCR


SCALE DRAWN
AS NOTED MPH

DRAWING SERIES
PROPOSED WORK

**EXISTING ELEVATIONS &** SECTIONS

LPC-008.00 SHEET 08 OF 12

Copyright © 2020 by nC2 architecture Ilc. All rights reserved.

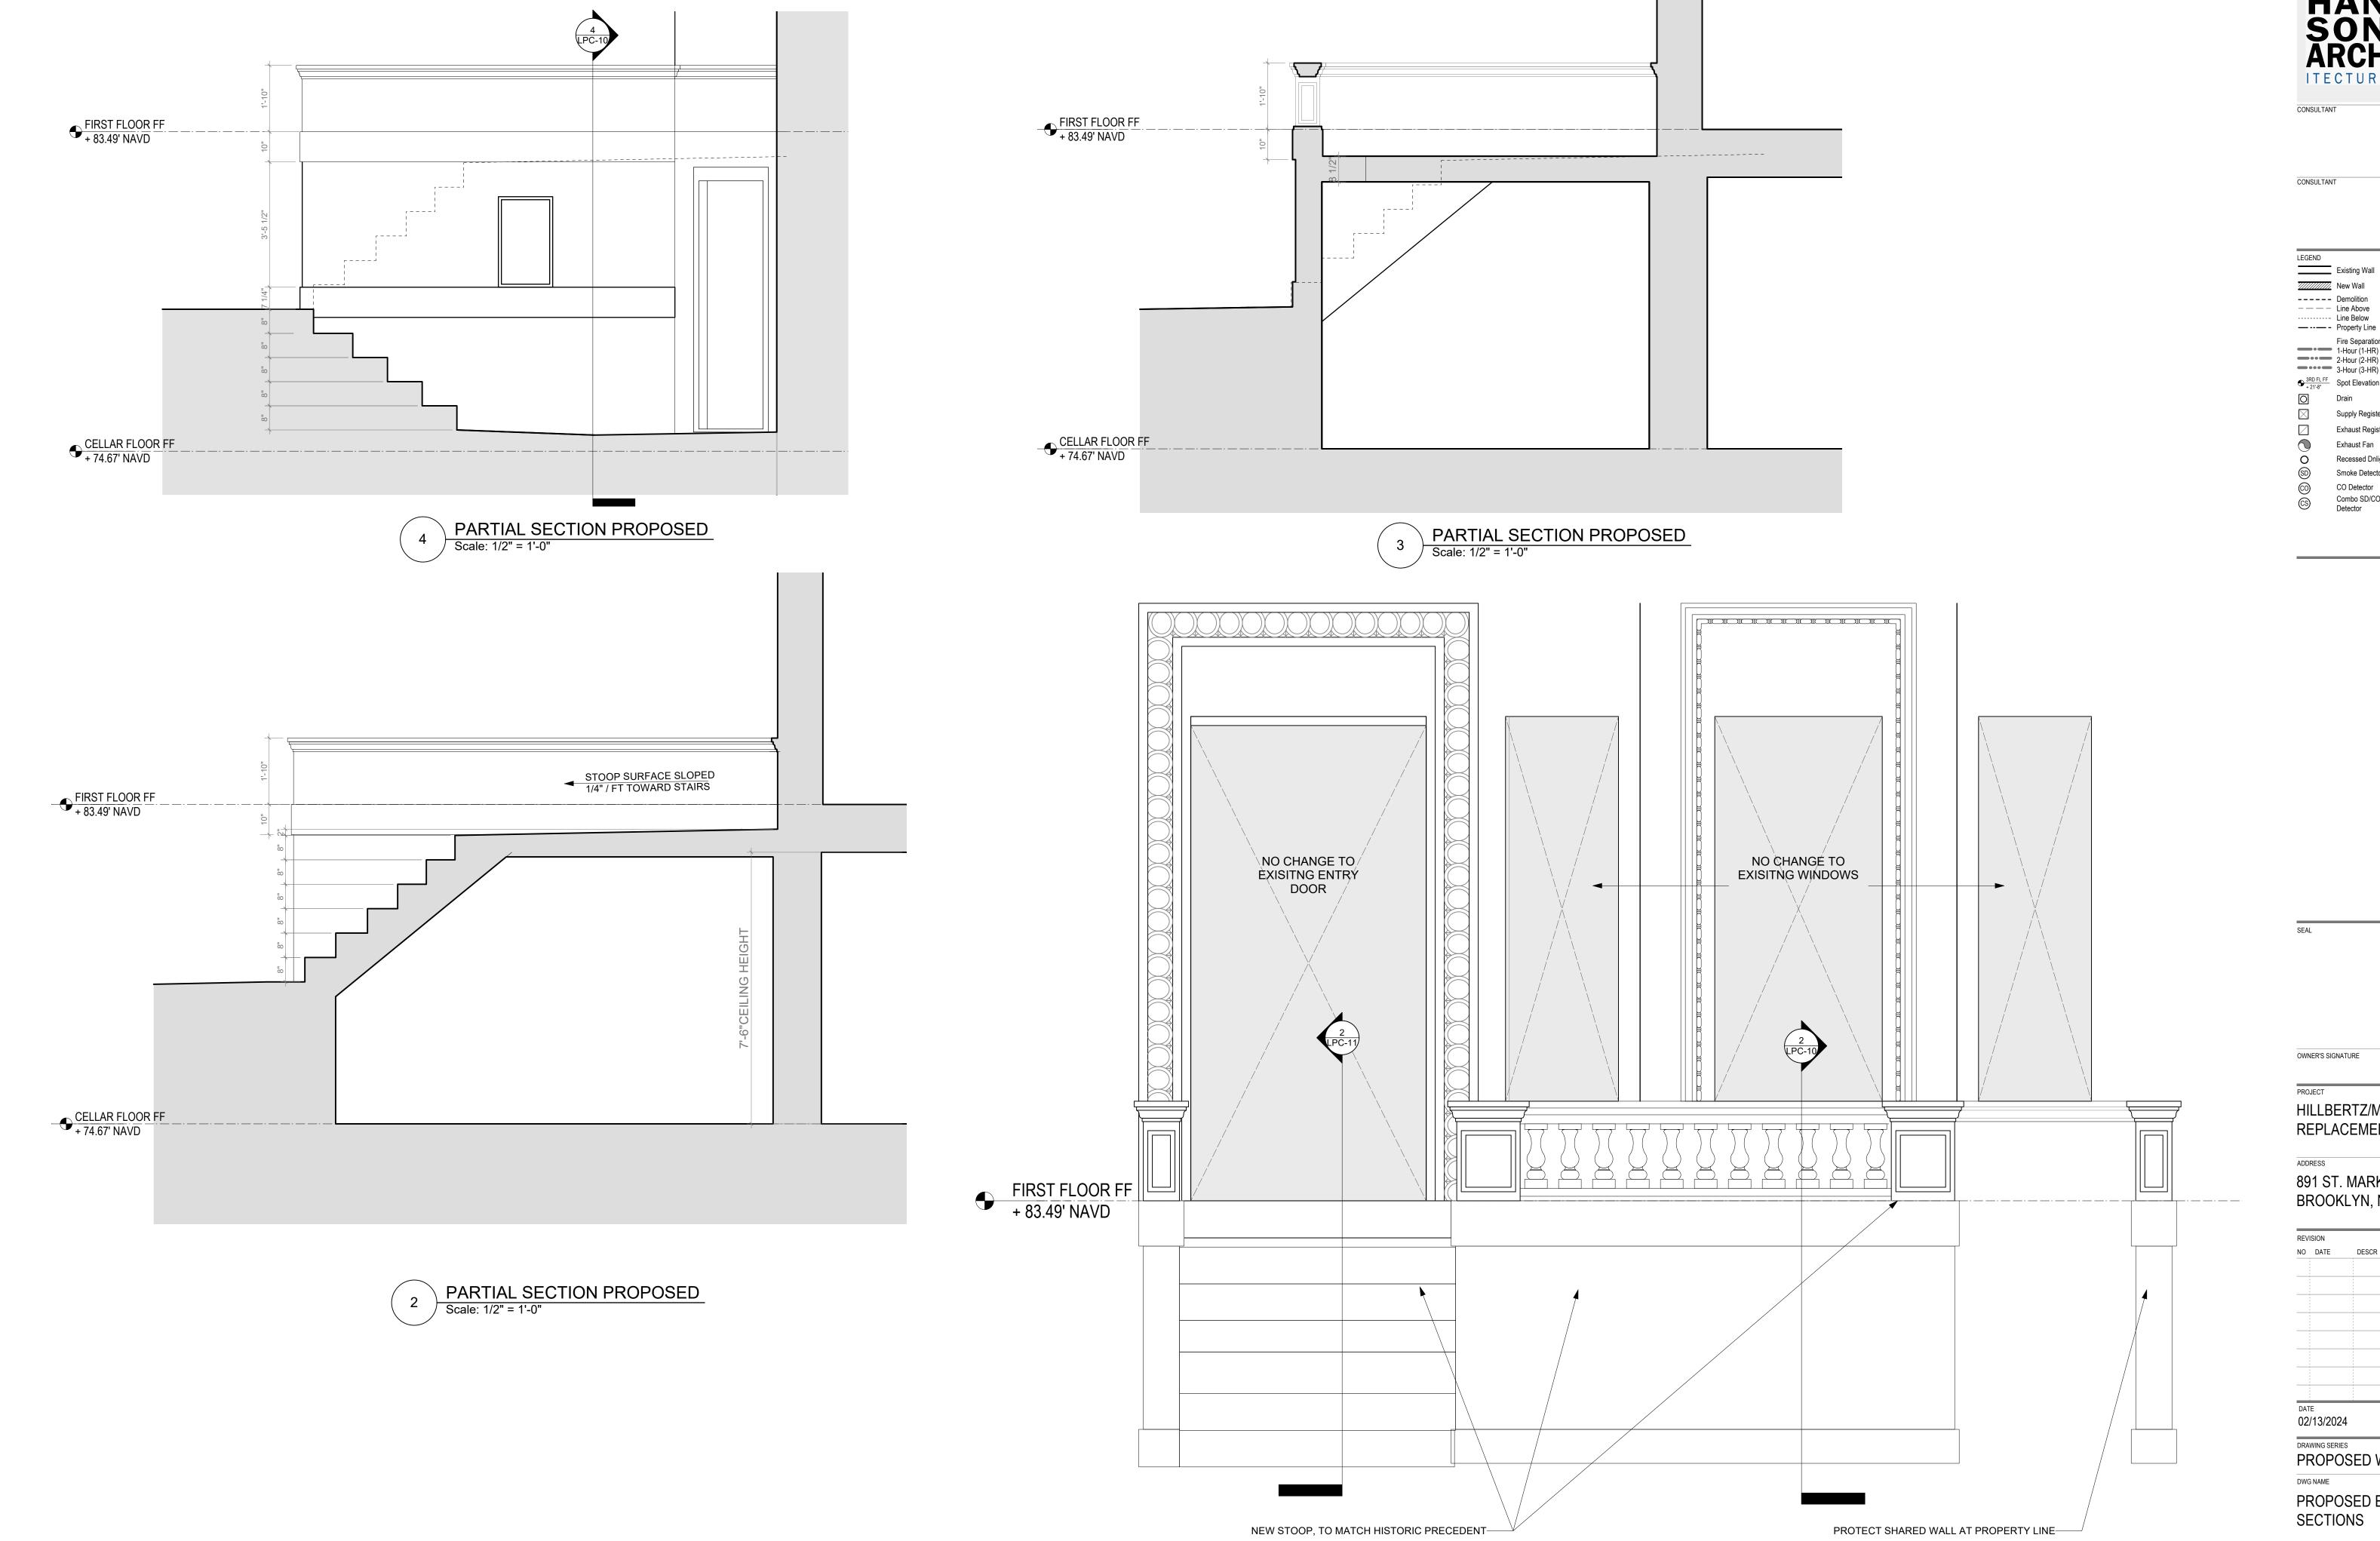

1 PARTIAL FRONT ELEVATION PROPOSED

Scale: 3/4" = 1'-0"

Hanson Architecture II
SON
SON
ARCH
ITECTURE

Hanson Architecture II
Brooklyn | Manhatt
279 E 44th St, #16K
New York NY 100
T 347 504 024
info@hanson-arch.co Brooklyn | Manhattan 279 E 44th St, #16K, New York NY 10017 T 347 504 0242

#T No. of Treads #R No. of Risers AD Area Drain AFF Above Fin Floor B/ Bottom of BO Bottom of CL Center Line EX'G Existing Fire Separation FD Floor Drain FF Finished Floor

1-Hour (1-HR) 2-Hour (2-HR) 3-Hour (3-HR) FO Finished Opening 3RD FL FF + 21'-8" Spot Elevation GA Gauge GWB Gypsum Wallboard IGU Insulated Glass Unit Supply Register MIN Minimum Exhaust Register PSI Pounds per Sq Inch PSF Pounds per Sq Foot

RO Rough Opening Recessed Dnlight SIM Similar SF Square Foot SI Square Inch CO Detector SG Safety Glass TEMP Temporary
TYP Typical
T/ Top of
TO Top of
VIF Verify in Field Combo SD/CO

OWNER'S SIGNATURE

HILLBERTZ/MOZO STOOP REPLACEMENT

891 ST. MARK'S AVE BROOKLYN, NY 11213


SCALE DRAWN
AS NOTED MPH 02/13/2024

DRAWING SERIES
PROPOSED WORK


PROPOSED ELEVATIONS &

LPC-009.00

SHEET 09 OF 12 Copyright © 2020 by nC2 architecture llc. All rights reserved.

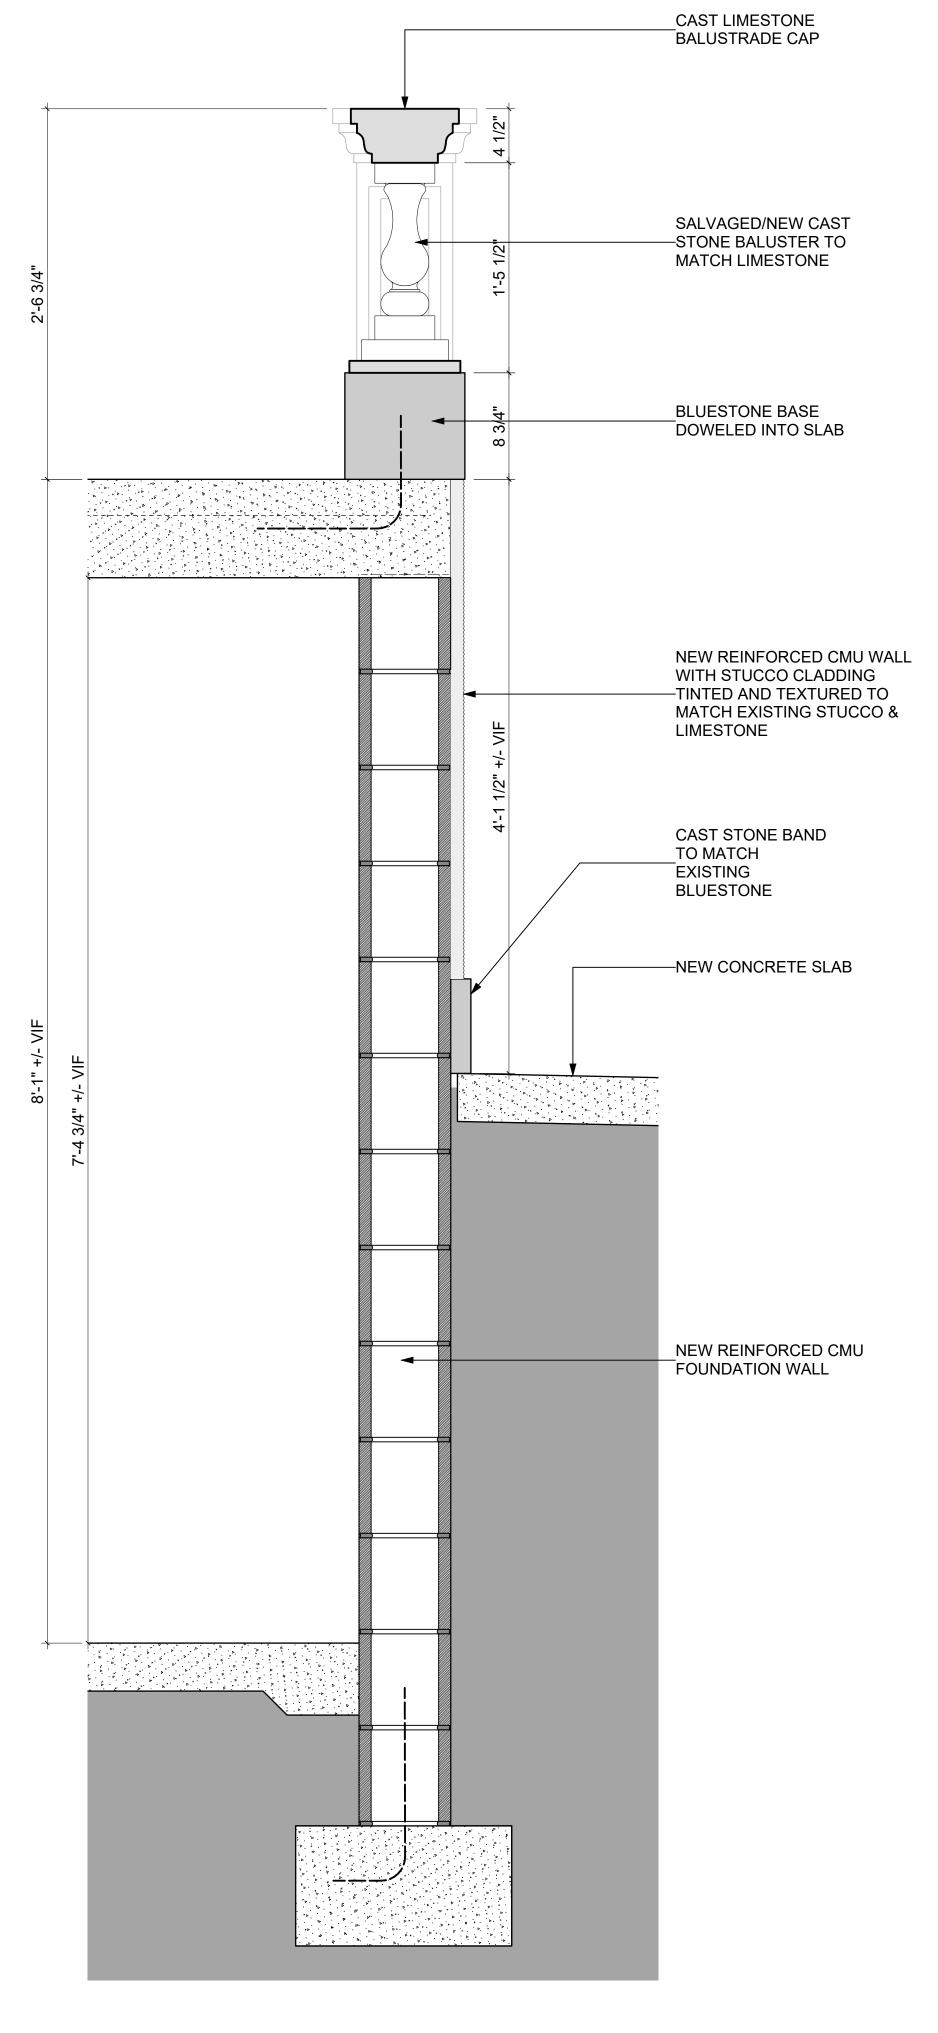

PROPOSED PARTIAL SECTION @ FRONT STOOP WALL
Scale: 1 1/2" = 1'-0"

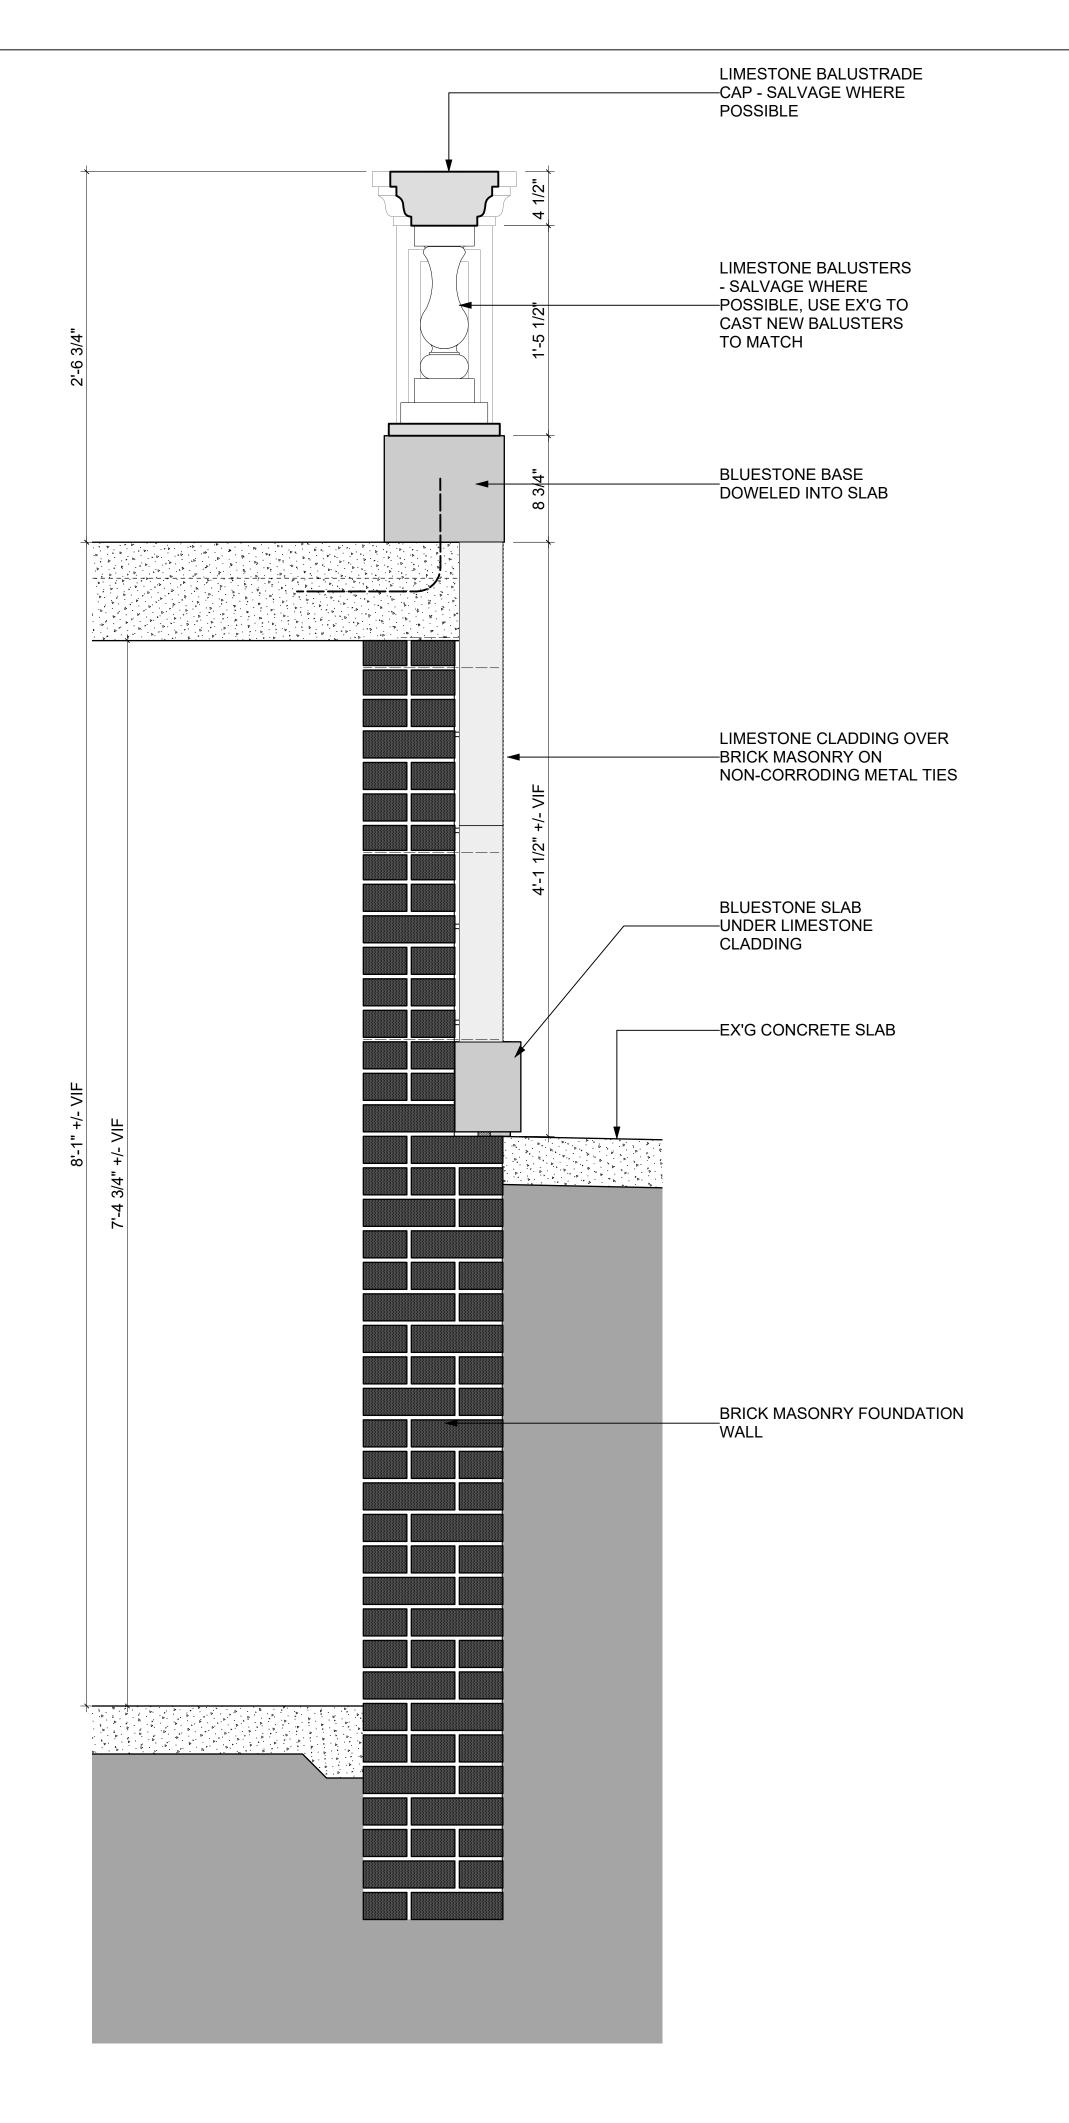

EXISTING PARTIAL SECTION @ FRONT STOOP WALL

Scale: 1 1/2" = 1'-0"

HAN Brooklyn | Manhattan 279 E 44th St, #16K, SON New York NY 10017 T 347 504 0242

CONSULTANT

LEGEND

CONSULTANT

Existing Wall # T No. of Treads # R No. of Risers AD Area Drain

---- Demolition AFF Above Fin Floor B/ Bottom of ---- Line Above BO Bottom of ----- Line Below CL Center Line — -- Property Line EX'G Existing Fire Separation FD Floor Drain 1-Hour (1-HR) FF Finished Floor 2-Hour (2-HR) 3-Hour (3-HR) Finished Opening

3RD FL FF + 21'-8" Spot Elevation GA Gauge GWB Gypsum Wallboard IGU Insulated Glass Unit Supply Register MIN Minimum Exhaust Register PSI Pounds per Sq Inch PSF Pounds per Sq Foot Exhaust Fan RO Rough Opening Recessed Dnlight SF Square Foot Square Inch CO Detector SG Safety Glass TEMP Temporary
TYP Typical
T/ Top of
TO Top of
VIF Verify in Field Combo SD/CO

OWNER'S SIGNATURE

HILLBERTZ/MOZO STOOP REPLACEMENT

891 ST. MARK'S AVE BROOKLYN, NY 11213

NO DATE DESCR


DATE SCALE DRAWN
02/13/2024 AS NOTED MPH

DRAWING SERIES
PROPOSED WORK


EX'G & PROPOSED STOOP FRONT WALL DETAIL

LPC-010.00

SHEET 10 OF 12 Copyright © 2020 by nC2 architecture llc. All rights reserved.

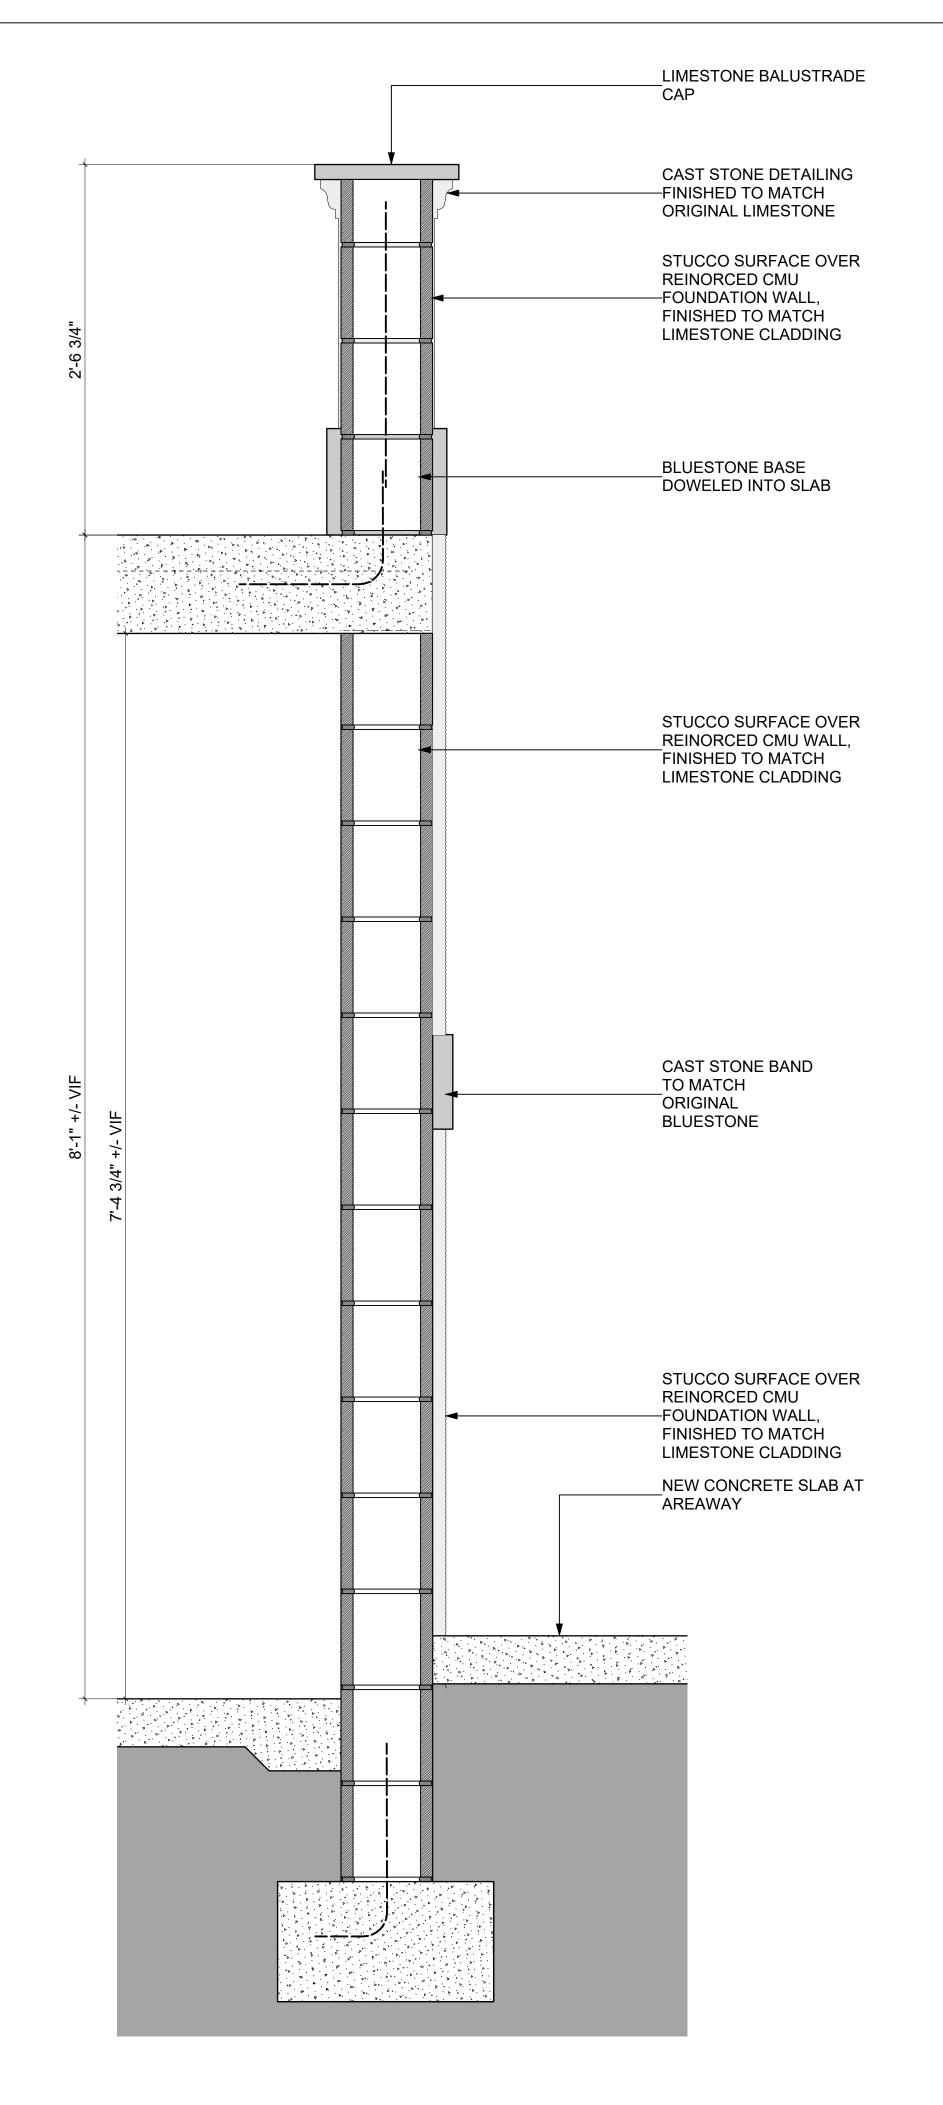

PROPOSED PARTIAL SECTION @ SIDE STOOP WALL
Scale: 1 1/2" = 1'-0"

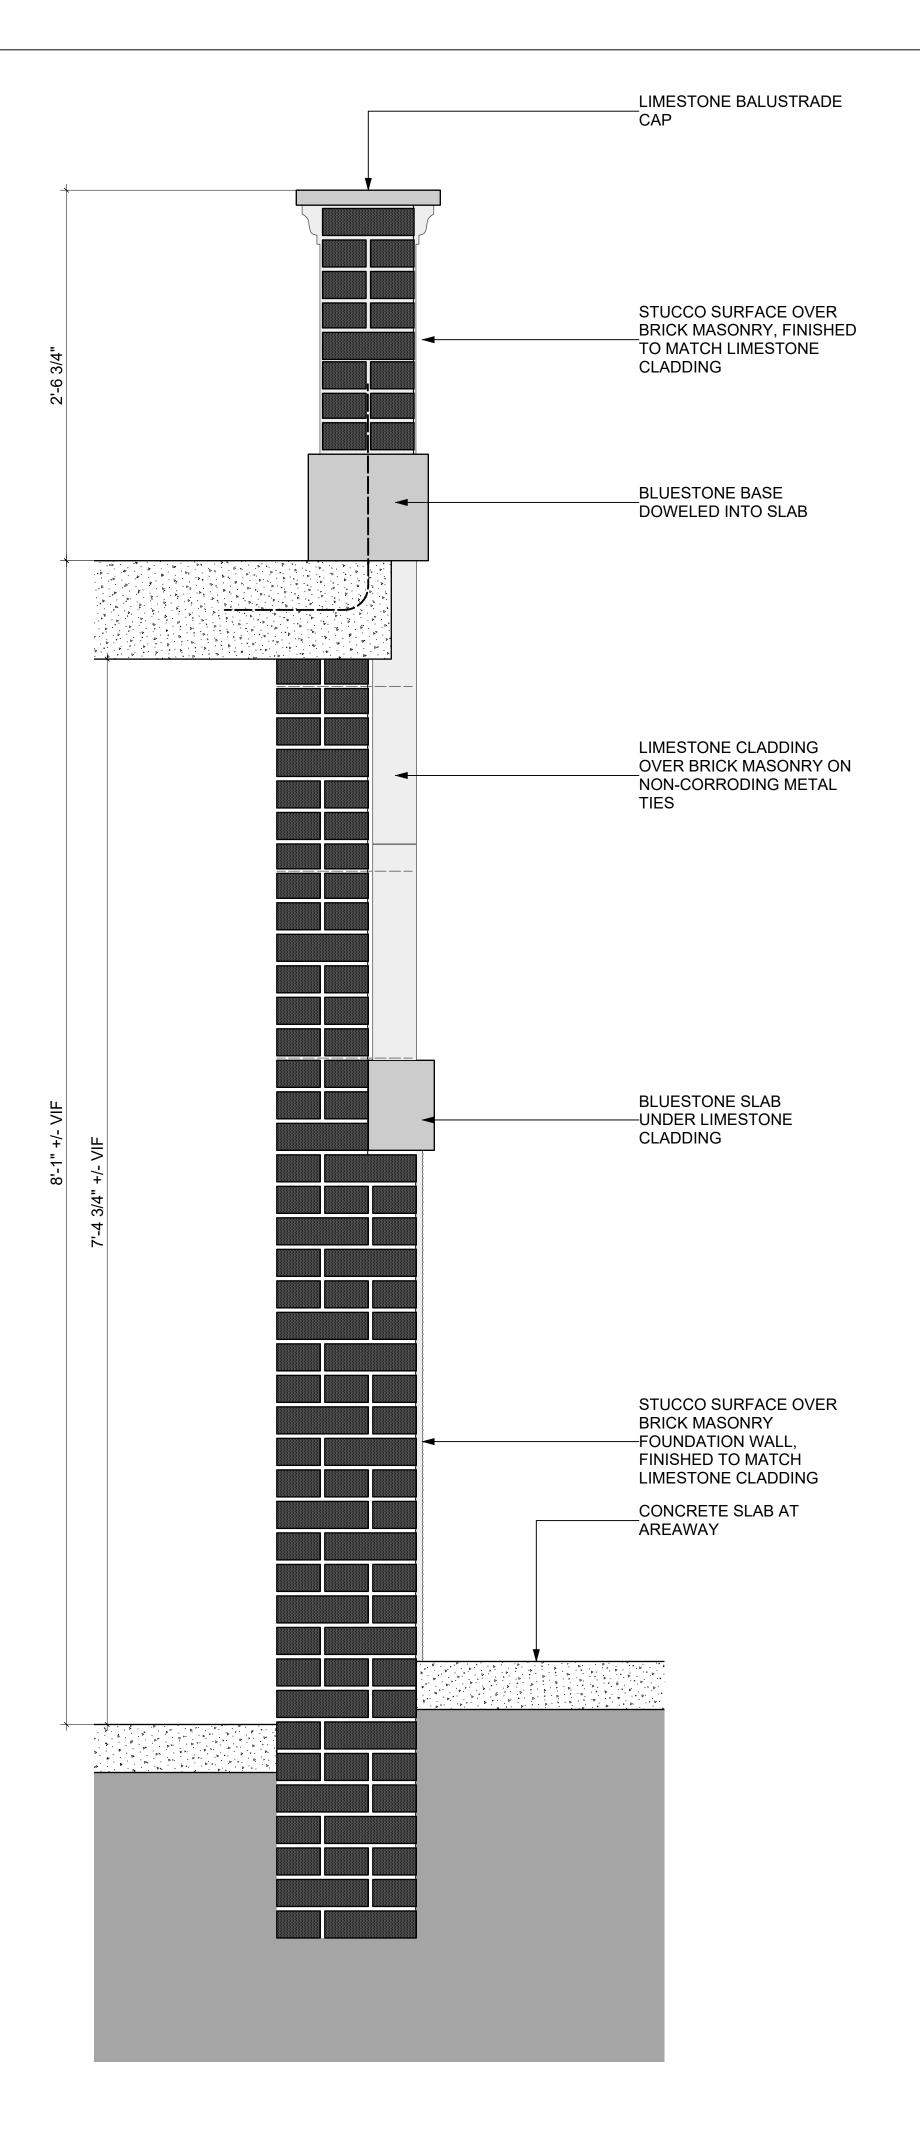

3 EX'G PARTIAL SECTION @ SIDE STOOP WALL
Scale: 1 1/2" = 1'-0"

HAN Brooklyn | Manhattan 279 E 44th St, #16K, SON New York NY 10017 T 347 504 0242

CONSULTANT

CONSULTANT

LEGEND

Existing Wall # T No. of Treads # R No. of Risers AD Area Drain AFF Above Fin Floor ---- Demolition B/ Bottom of ---- Line Above BO Bottom of ----- Line Below CL Center Line — -- Property Line

EX'G Existing Fire Separation FD Floor Drain 1-Hour (1-HR) FF Finished Floor 2-Hour (2-HR) 3-Hour (3-HR) Finished Opening 3RD FL FF + 21'-8" Spot Elevation GA Gauge GWB Gypsum Wallboard IGU Insulated Glass Unit Supply Register MIN Minimum Exhaust Register PSI Pounds per Sq Inch

PSF Pounds per Sq Foot Exhaust Fan RO Rough Opening Recessed Dnlight SIM Similar SF Square Foot Square Inch CO Detector SG Safety Glass TEMP Temporary
TYP Typical
T/ Top of
TO Top of
VIF Verify in Field Combo SD/CO

OWNER'S SIGNATURE

HILLBERTZ/MOZO STOOP REPLACEMENT

BROOKLYN, NY 11213

ADDRESS 891 ST. MARK'S AVE

REVISION NO DATE DESCR


SCALE DRAWN
AS NOTED MPH 10/21/2024

PROPOSED WORK

EX'G & PROPOSED STOOP SIDE WALL DETAIL

LPC-011.00

SHEET 11 OF 12 Copyright © 2020 by nC2 architecture llc. All rights reserved.

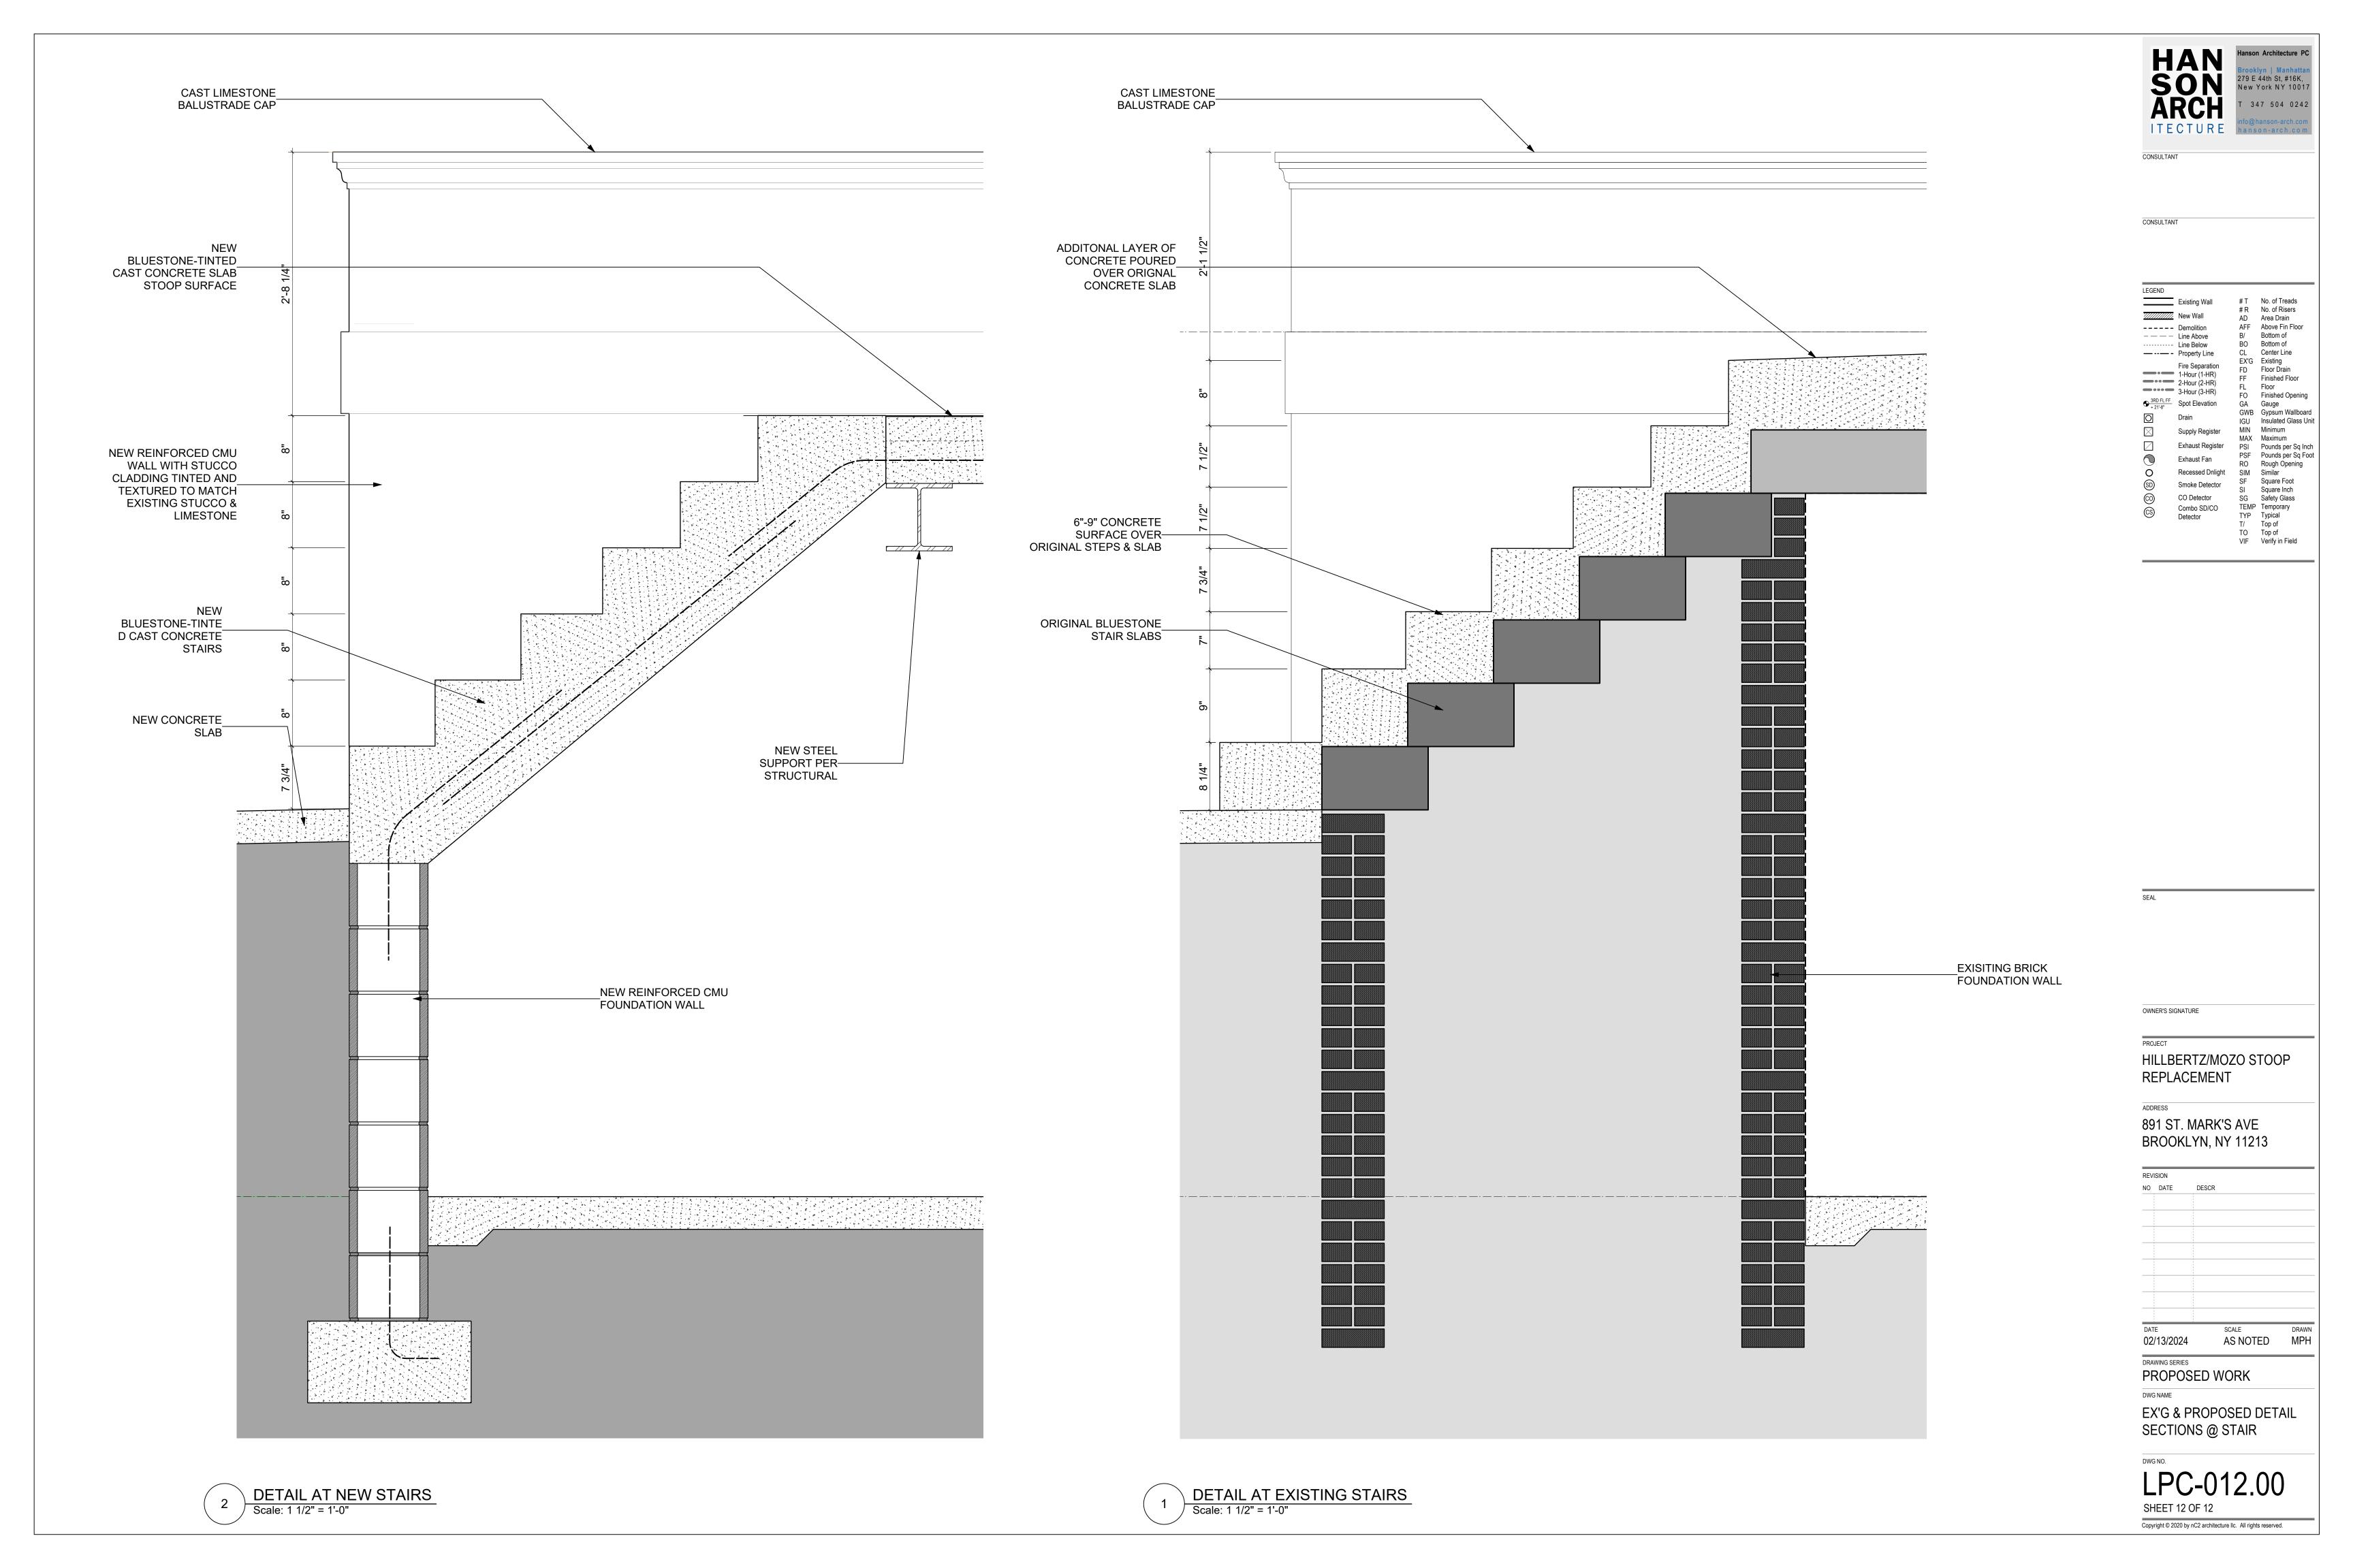



#### FIELD OBSERVATION REPORT

JOB NAME:	891 St Marks – Stoop	REPORT NO:	01
	Reconstruction		
JOB NO:	230127	DATE:	05/10/2024
LOCATION:	Brooklyn, NY 11213	BY:	PC
CLIENT:	Derrick Hilbertz	DATE ON SITE:	2024-03-25
CONTRACTOR:	N/A	TIME ON SITE	10:00-12:00pm
ATTENTION:	Michael P. Hanson	WEATHER:	Sunny
COPY TO:		PEOPLE -	KJT
		ORG.	
		PRESENT:	

#### **REASON FOR VISIT:**

We were called on site to evaluate the condition of the existing stoop at 891 St Marks. This report assesses the structural integrity and safety of the stoop.

#### **SUMMARY:**

We have observed several structural issues and severe deterioration of the existing stoop. The structural slab is corroded, and its load-bearing capacity compromised, the supporting masonry wall is cracking, and the outside stone walls are leaning. The presence of water infiltration exacerbates these issues, accelerating the deterioration process and compromising the integrity of the entire structure.

#### **RECCOMENDATIONS:**

It is recommended that the entire stoop is to be reconstructed rather than opting for repair or partial reconstruction.

The corrosion of the slab, wall cracks, and water infiltration indicate widespread structural deterioration behind what we were able to observe.

- Repairing or partial reconstruction would not adequately address the issues and may lead
  to further complications in the future. In addition, partial repairs may provide temporary
  relief but are likely to be costlier in the long run due to recurrent maintenance and potential
  future failures.
- Reconstructing the entire stoop allows for a comprehensive solution that addresses all structural deficiencies and ensures the long-term stability and durability of the structure.

See next pages for itemized observations and pictures.



### **FIELD OBSERVATION REPORT**

#### **OBSERVATIONS MADE ON 2024/03/25:**

No.	RVATIONS MADE ON 2024/03/25: Observation	Photo
1.01	Observation: The interior bearing masonry wall is deteriorated and shows extensive cracking.  Action Required: See recommendations.	
1.02	Observation: Water infiltration are deteriorating and weakening the supporting stoop structure.  Action Required: See recommendations.	



#### **FIELD OBSERVATION REPORT**

#### 1.03 **Observation:**

The leaning of the stone walls are observable on the outside. This is due to the weakening of the supporting structure.

#### **Action Required:**

See recommendations.



#### 1.04 **Observation**:

The underside of the slab is corroded, reinforcement is exposed and entire portion of concrete cover has spalled and fallen off.

#### **Action Required:**

See recommendations.



The above is a FIELD OBSERVATION report and shall not be used for SPECIAL INSPECTIONS as required by the governing building code. This report constitutes our observations on the date(s) stated above. Observations are limited to conditions described in the Construction Documents as they relate to the Building in its final condition. Means and Methods and temporary conditions are the responsibility of the General Contractor and are explicitly excluded from our scope of work unless we have a specific contract with the General Contractor that says otherwise.



## The current proposal is:

Preservation Department – Item 3, LPC-24-08616

# 891 St Mark's Avenue – Crown Heights North Historic District Borough of Brooklyn

To testify virtually, please join Zoom

Webinar ID: 820 4014 2259

Passcode: 476351

By Phone: 646-558-8656 (NY)

877-853-5257 (Toll free) US

888-475-4499 (Toll free)

**Note**: If you want to testify virtually on an item, join the Zoom webinar at the agenda's "Be Here by" time (about an hour in advance). When the Chair indicates it's time to testify, "raise your hand" via the Zoom app if you want to speak (\*9 on the phone). Those who signed up in advance will be called first.